BCCC Stage 6 - Gym + GLA

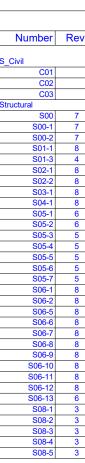
14 Boucaut Avenue, Blakeview. S.A. 5144



Drawing Register		
Number	Rev.	Sheet Name
chitectural		
A01-1	4	SITE PLAN
A02-1	4	GROUND FLOOR PLAN
A02-2	4	FIRST FLOOR PLAN
A02-3	3	GRID SETOUT PLAN
A02-4	3	GROUND FLOOR DIMENSION PLAN
A02-5	3	FIRST FLOOR DIMENSION PLAN
A03-1	3	REFLECTED CEILING PLAN - GROUND FLOOR
A03-1	3	REFLECTED CEILING PLAN - FIRST FLOOR
A04-1	4	ROOF PLAN
A05-1	4	ELEVATION SHEET 1 - OVERALL
A05-1	4	ELEVATION SHEET 2 - OVERALL
A05-2	3	ELEVATION SHEET 3 - PART
A05-5	3	ELEVATION SHEET 4 - PART
A06-1	4	SECTION SHEET 1
A06-2	3	SECTION SHEET 2
A06-3	3	SECTION SHEET 3
A06-4	3	SECTION SHEET 4
A07-1	2	PLAN DETAILS - SHEET 1
A07-2	2	PLAN DETAILS - SHEET 2
A07-3	2	PLAN DETAILS - SHEET 3
A07-4	2	PLAN DETAILS - SHEET 4
A07-5	2	SECTION DETAILS - SHEET 1
A07-6	2	SECTION DETAILS - SHEET 2
A07-7	2	SECTION DETAILS - SHEET 3
A07-8	2	SECTION DETAILS - SHEET 4
A07-9	2	SECTION DETAILS - SHEET 5
A07-10	2	SECTION DETAILS - SHEET 6
A08-1	3	STAIR DETAIL SHEET 1
A08-2	2	STAIR DETAIL SHEET 2
A08-3	3	STAIR DETAIL SHEET 3
A09-1	3	DWC DETAILS
A09-2	3	WET AREA DETAILS
A09-4	3	WET AREA SETOUT PLANS - FIRST FLOOR
A10-1	2	FINISHES PLAN - GROUND FLOOR
A10-2	2	FINISHES PLAN - FIRST FLOOR
A11-1	-	INTERNAL ELEVATION - SHEET 1

	Drawing Register		
Number	Rev.	Sheet Name	
A11-2		INTERNAL ELEVATION - SHEET 2	
A11-3		INTERNAL ELEVATION - SHEET 3	
A11-4		INTERNAL ELEVATION - SHEET 4	
A12-1		JOINERY DETAIL - SHEET 1	
A12-2		JOINERY DETAIL - SHEET 2	
A12-3		JOINERY DETAIL - SHEET 3	
A12-4		JOINERY DETAIL - SHEET 4	
A13-1	2	DOOR SCHEDULE	
A13-5	2	WINDOW SCHEDULE - SHEET 1 - GROUND FLOOR	
A13-6	2	WINDOW SCHEDULE - SHEET 2 - GROUND FLOOR	
A13-7	2	WINDOW SCHEDULE - SHEET 3 - FIRST FLOOR	
A13-8	2	WINDOW SCHEDULE - SHEET 4 - ROOF LEVEL	

		Drawing Register	
Number Rev. Sheet Name			
Electrical			
E01	2	SITE ELECTRICAL PLAN	
E02	2	GROUND FLOOR POWER & DATA PLAN	
E03	2	FIRST FLOOR POWER & DATA PLAN	
E04	2	ELECTRICAL LIGHTING PLAN - GROUND	
E05	2	ELECTRICAL LIGHTING PLAN - FIRST FLOOR	
Fire			
F01	2	SITE FIRE PLAN	
F02	2	GROUND FLOOR FIRE PLAN	
F03	2	FIRST FLOOR FIRE PLAN	
Hydraulic			
H01	4	HYDRAULICS - SITE PLAN	
H02	4	HYDRAULICS PLAN - GROUND FLOOR	
H03	4	HYDRAULICS PLAN - GROUND - PART FLOOR	
H04	4	HYDRAULICS PLAN - FIRST FLOOR	
H08	1	HYDRAULIC DETAILS	
Mechanical			
M01	2	GROUND FLOOR MECHANICAL PLAN	
M02	2	FIRST FLOOR MECHANICAL PLAN	
M03	2	ROOF MECHANICAL PLAN	
M04	1	MECHANICAL DETAILS	



3

When sheet printed full size, the scale bar is 100mm. 50 100

	Drawing Register		
٧.	Sheet Name		
	1		
	CIVIL PLAN		
	CIVIL DETAILS		
	CIVIL - ALL SERVICES PLAN		
	STRUCTURAL NOTES		
	STRUCTURAL 3D VIEW - SHEET 1		
	STRUCTURAL 3D VIEW - SHEET 2		
	FOOTING / SLAB PLAN		
	FIRST FLOOR SLAB PLAN		
	GROUND FLOOR STEEL PLAN		
	FIRST FLOOR STEEL PLAN		
	ROOF STEELWORK PLAN		
	PANEL PLAN		
	PANEL ELEVATION - SHEET 1		
	PANEL ELEVATION - SHEET 2		
	PANEL ELEVATION - SHEET 3		
	PANEL ELEVATION - SHEET 4		
	PANEL ELEVATION - SHEET 5		
	PRECAST BLEACHERS / PLATS - SHEET 6		
	PRECAST BLEACHERS / PLATS - SHEET 7		
	STEELWORK ELEVATION-SHEET 1		
	STEELWORK ELEVATION-SHEET 2		
	STEELWORK SECTIONS-SHEET 1		
	STEELWORK SECTIONS-SHEET 2		
	STEELWORK SECTIONS-SHEET 3		
	STEELWORK SECTIONS-SHEET 4		
	STEELWORK SECTIONS-SHEET 5		
	STEELWORK SECTIONS-SHEET 6		
	STEELWORK SECTIONS-SHEET 7		
	STEELWORK SECTIONS-SHEET 8		
	STEELWORK SECTIONS-SHEET 9		
	TYPICAL STEEL DETAILS - SHEET 1		
	TYPICAL STEEL DETAILS - SHEET 2		
	TYPICAL STEEL DETAILS - SHEET 3		
	TYPICAL CONCRETE DETAILS		
	TYPICAL PRECAST DETAILS		

4	Issued for Building Rules Consent 30/06/22		
3	Updated Plans	28/06/22	
2	Updated Plans	06/06/22	
1	Updated Plans	23/05/22	
Issue Amendments Date			
Proj	ect		
14	Boucaut Avenue, Blakev	iow	

Drawing COVER SHEET



16-22 Erudina Ave, Edwardstown S.A. 5039 Ph (08) 8277 0111 Fax(08) 8277 2255 Commercial - Industrial - Domestc

Date :		23/05/22
Drawn :		
Scale :	(@ A1) or	(@ A3)

© COPYRIGHT Drawing Number : A00.4

Contractors must verify all dimensions at the job se before commencing work or making shop drawings.



<u>Site Plan</u> 1:400

LEGEND:



PROPOSED BUILDING - STAGE 6 GYM & GLA GROUND FLOOR AREA = 2726m2 FIRST FLOOR AREA = 1285m2 TOTAL BUILDING AREA (GND+FIRST) = 4011m2 EXTENT OF STAGE 6 SCOPE OF WORKS.

BI ACK

4	4 Issued for Building Rules Consent 30/06/22				
3	Updated Plans	28/06/22			
2	Updated Plans	06/06/22			
1	Updated Plans	23/05/22			
Issu	e Amendments	Date			
Pro	Project				
BC	CCC Stage 6 - Gym + GL/	4			
14	Boucaut Avenue, Blakev	iew. S.A.			
51	5144				

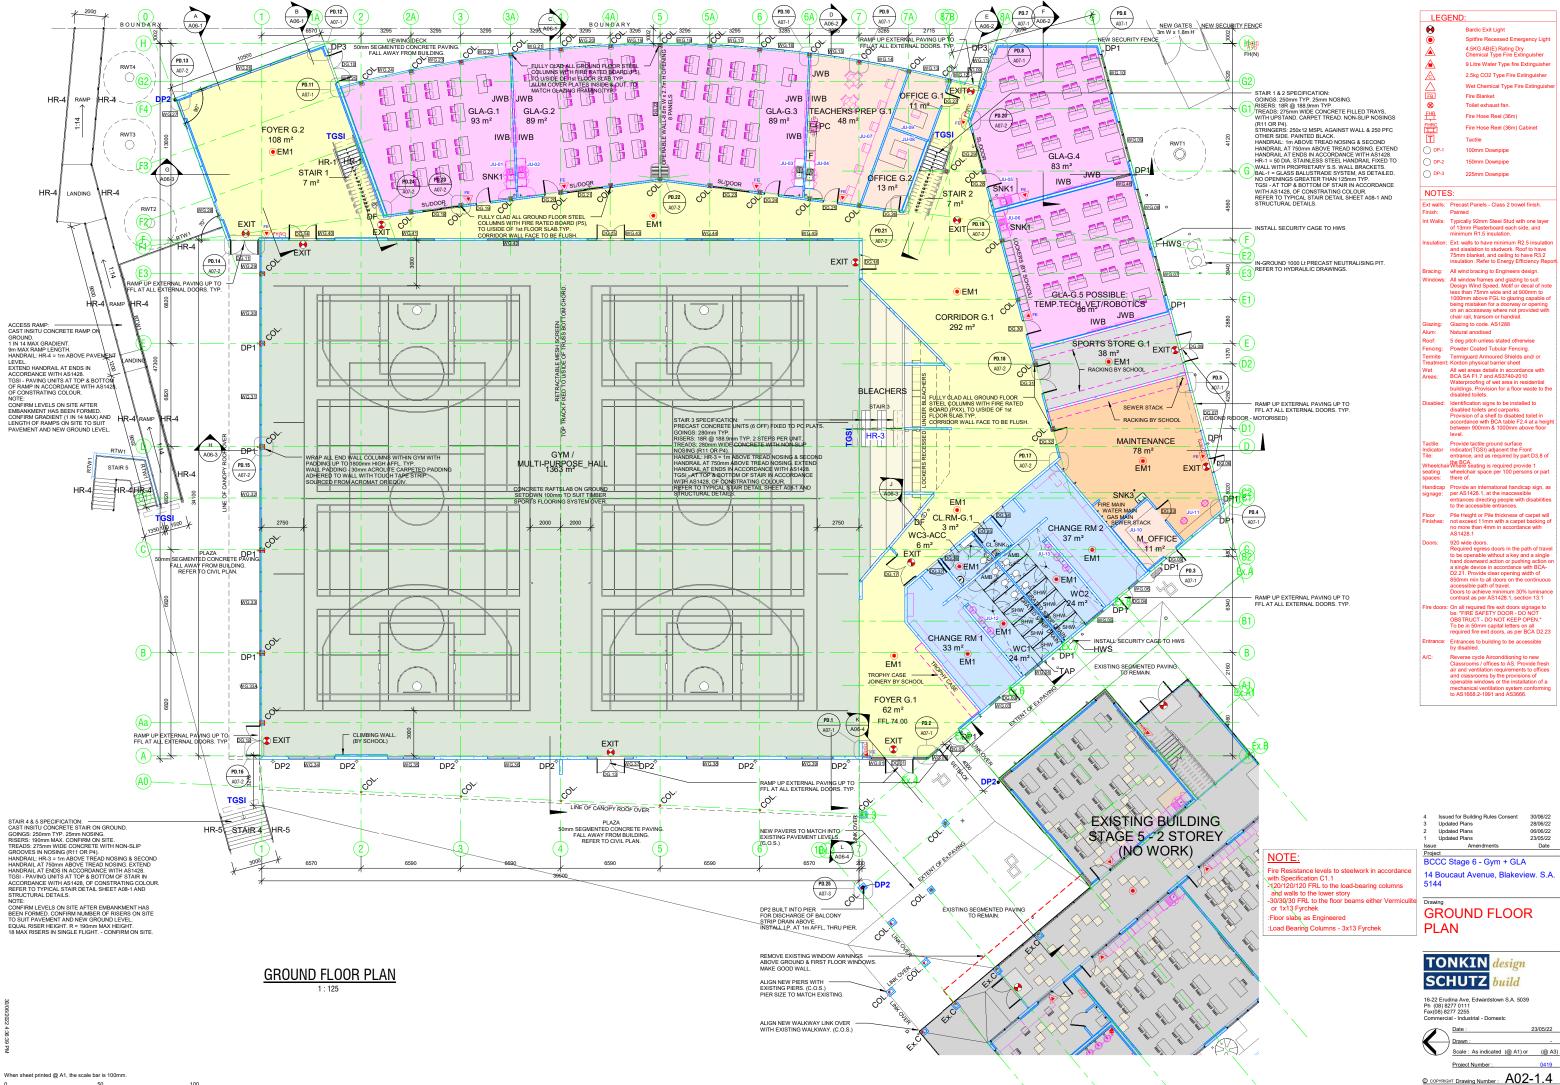
Drawing SITE PLAN



16-22 Erudina Ave, Edwardstown Ph (08) 8277 0111 Fax(08) 8277 2255 Commercial - Industrial - Domest Date Drawn :




Contractors must verify all dimensions at the jo before Not for Construction until approved by Statutory ncing work or making shop drawings



Contractors must verify all dimensions at the job Not for Construction until approved by Statutory Authorities before

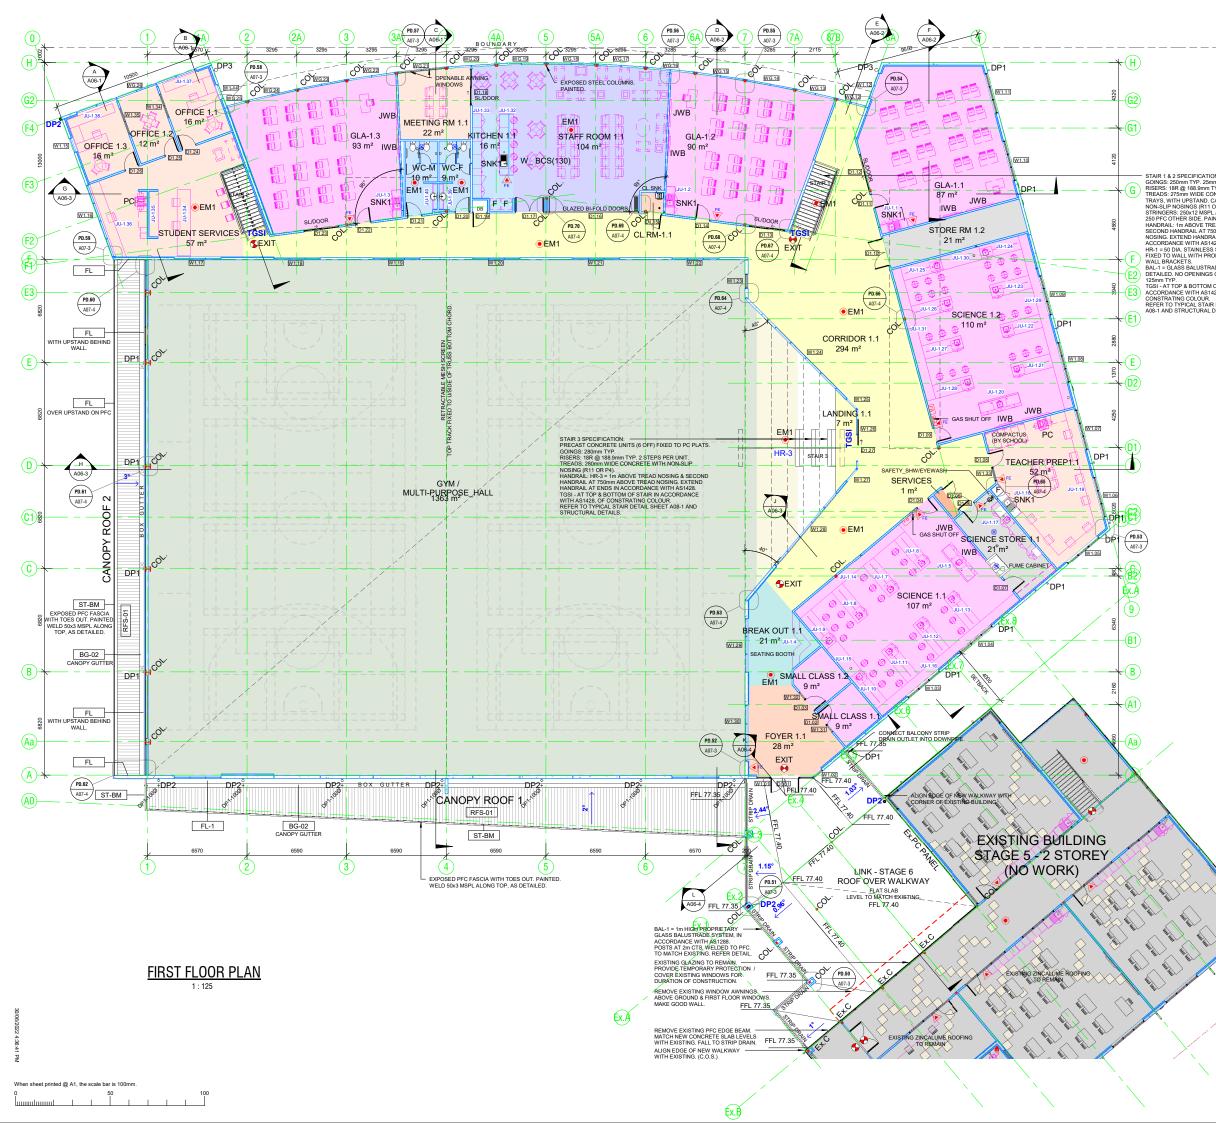commencing work or making shop drawings.



	NOTE:	LEG	END:
		0	Bardic Exit Light
	Fire Resistance levels to steelwork in accordance with Specification C1.1	ŏ	Spitfire Recessed Emergency Light
	-120/120/120 FRL to the load-bearing columns	À	4.5KG AB(E) Rating Dry Chemical Type Fire Extinguisher
	and walls to the lower story -30/30/30 FRL to the floor beams either Vermiculite		9 Litre Water Type fire Extinguisher
	or 1x13 Fyrchek		2.5kg CO2 Type Fire Extinguisher
	:Floor slabs as Engineered		Wet Chemical Type Fire Extinguisher
	:Load Bearing Columns - 3x13 Fyrchek	l 🚔	Fire Blanket
		8	Toilet exhaust fan.
	Amenities	野	Fire Hose Reel (36m)
		FHRC	Fire Hose Reel (36m) Cabinet
	Balcony	Ē	Tactile
	Dalcony	() DP-1	100mm Downpipe
	Draskaut Onasa	O DP-2	150mm Downpipe
'ION: imm NOSING.	Breakout Space	O DP-3	225mm Downpipe
n TYP. CONCRETE FILLED		0	
. CARPET TREAD. 1 OR P4).	Circulation	NOTE	S:
PL AGAINST WALL &		Ext walls:	Precast Panels - Class 2 trowel finish.
AINTED BLACK. READ NOSING &	Foyer	Finish:	Painted
750mm ABOVE TREAD RAIL AT ENDS IN		Int Walls:	Typically 92mm Steel Stud with one layer of 13mm Plasterboard each side, and
1428. SS STEEL HANDRAIL	GLA	Incudetions	minimum R1.5 insulation. Ext. walls to have minimum R2.5 insulation
ROPRIETARY S.S.		insulation:	and sisalation to studwork. Roof to have
RADE SYSTEM, AS	Gym		75mm blanket, and ceiling to have R3.2 insulation. Refer to Energy Efficiency Report.
S GREATER THAN		Bracing:	All wind bracing to Engineers design.
M OF STAIR IN 1428, OF	Maintenance	Windows:	All window frames and glazing to suit Design Wind Speed. Motif or decal of note
R. IR DETAIL SHEET	Walltenance		less than 75mm wide and at 900mm to 1000mm above FGL to glazing capable of
L DETAILS.	Office		being mistaken for a doorway or opening
	Office		on an accessway where not provided with chair rail, transom or handrail.
		Glazing: Alum:	Glazing to code. AS1288 Natural anodised
	Outdoor Learning	Roof:	5 deg pitch unless stated otherwise
		Fencing:	Powder Coated Tubular Fencing.
	Seating / Bleachers	Termite Treatment	Termiguard Armoured Shields and/ or Kordon physical barrier sheet
		Wet	All wet areas details in accordance with
	Services	Areas:	BCA SA F1.7 and AS3740-2010 Waterproofing of wet area in residential
			buildings. Provision for a floor waste to the disabled toilets.
	Staff Room	Disabled:	Identification signs to be installed to
			disabled toilets and carparks. Provision of a shelf to disabled toilet in
	Store		accordance with BCA table F2.4 at a height between 900mm & 1000mm above floor
			level.
		Tactile Indicator	Provide tactile ground surface indicator(TGSI) adjacent the Front
		Tile:	entrance, and as required by part D3.8 of the BCA. rWhere seating is required provide 1
		seating	wheelchair space per 100 persons or part
		spaces:	there of.

		00/00/00		
4	Issued for Building Rules Consent	30/06/22		
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2	Updated Plans 06/06/22			
1	1 Updated Plans 23/05/22			
Issue	Issue Amendments Date			
Proje	ect			
BC	BCCC Stage 6 - Gym + GLA			
14 Boucaut Avenue, Blakeview. S.A.				

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Drawing FIRST FLOOR PLAN



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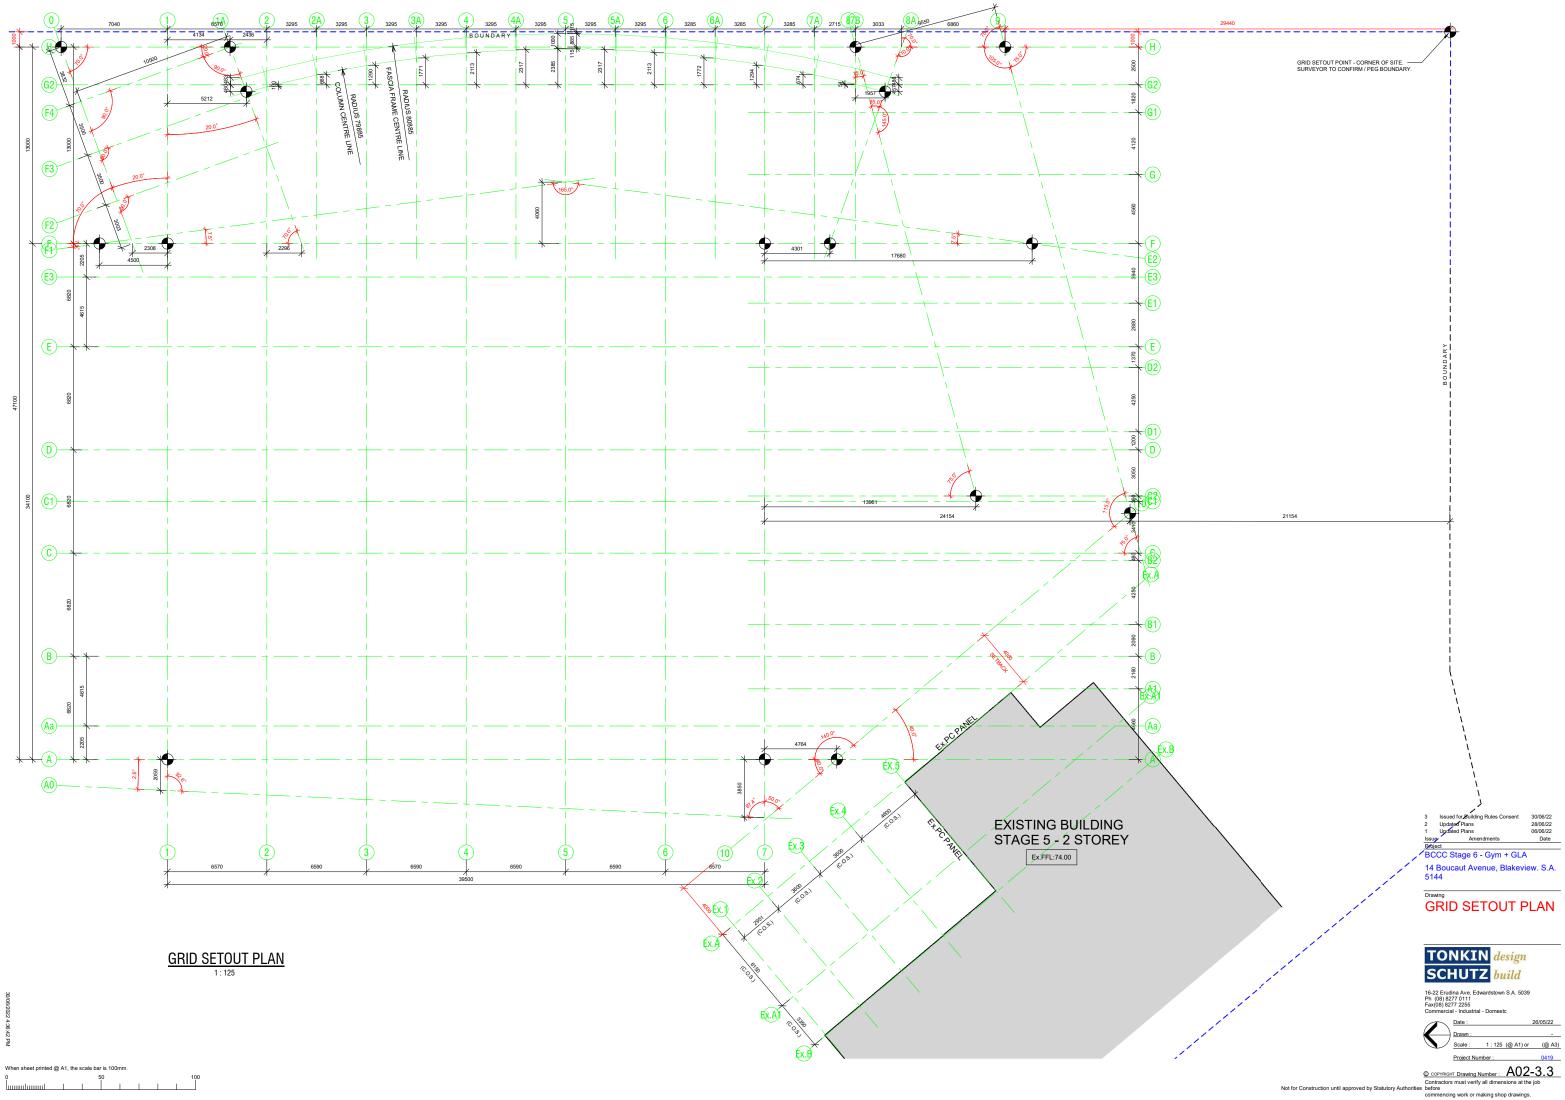



Scale : As indicated (@ A1) or (@ A3) Project Number : 0419 © COPYRIGHT Drawing Number : A02-2.4


Contractors must verify all dimensions at the j

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cing work or making shop drawing





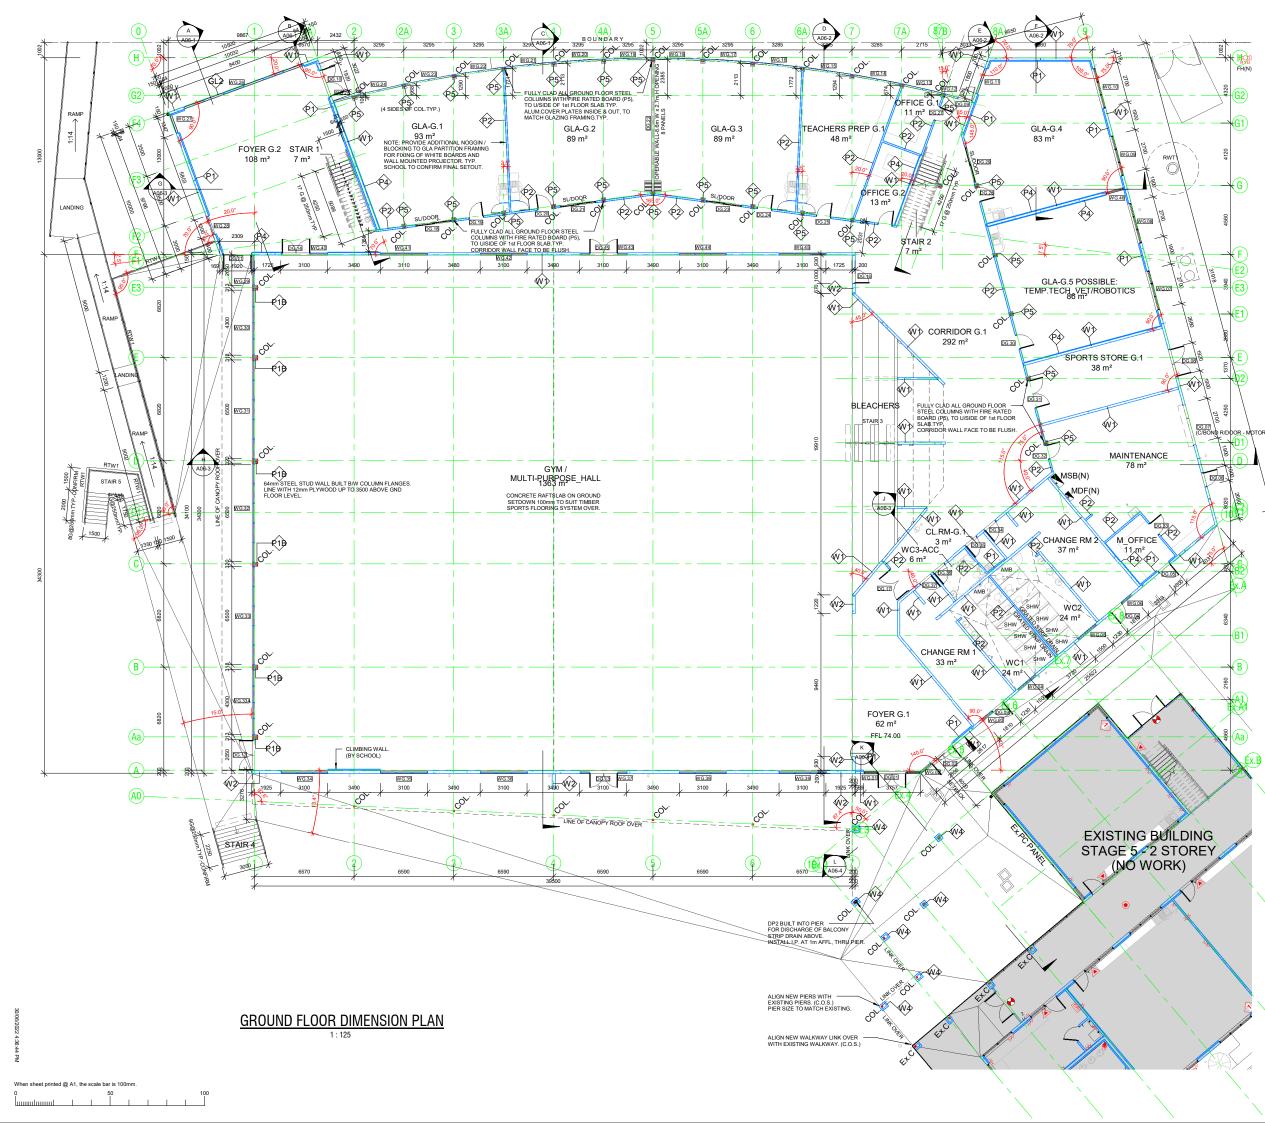

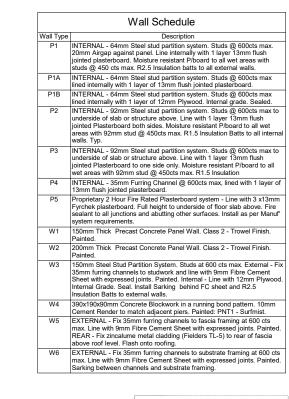NOTE:

Fire Resistance levels to steelwork in accordan with Specification C1.1 -120/120/120 FRL to the load-bearing columns and walls to the lower story -30/30/30 FRL to the floor beams either Ve or 1x13 Fyrchek :Floor slabs as Engineered :Load Bearing Columns - 3x13 Fyrchek

NOTES:

All plasterboard sheeting to be stopped and flushed.

Where Hardiflex and Alucobond are used as external wall cladding, provide a permeable sarking membrane between furring channels and wall framing.

Air-cell insulbreak 80 or approved equivalent

Provide timber blocking in framing to take joinery and Handrails and Grabrai



Drawing **GROUND FLOOR DIMENSION PLAN**




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© COPYRIGHT Drawing Number : A02-4.3 Contractors must verify all dimensions at the jo before

ncing work or making shop drawings



Wall Schedule		
Wall Type	Description	
P1	INTERNAL - 64mm Steel stud partition system. Studs @ 600cts max. 20mm Airgap against panel. Line internally with 1 layer 13mm flush jointed plasterboard. Moisture resistant Piboard to all wet areas with studs @ 450 cts max. R2.5 Insulation batts to all external walls.	
P1A	INTERNAL - 64mm Steel stud partition system. Studs @ 600cts max lined internally with 1 layer of 13mm flush jointed plasterboard.	
P1B	INTERNAL - 64mm Steel stud partition system. Studs @ 600cts max lined internally with 1 layer of 12mm Plywood. Internal grade. Sealed.	
P2	INTERNAL - 92mm Steel stud partition system. Studs @ 600cts max to underside of slab or structure above. Line with 1 layer 13mm flush jointed Plasterboard both sides. Moisture resistant P/board to all wet areas with 92mm stud @ 450cts max. R1.5 insulation Batts to all internal walls. Typ.	
P3	INTERNAL - 92mm Steel stud partition system. Studs @ 600cts max to underside of slab or structure above. Line with 1 layer 13mm flush jointed Plasterboard to one side only. Moisture resistant P/board to all wet areas with 92mm stud @ 450cts max. R1.5 Insulation	
P4	INTERNAL - 35mm Furring Channel @ 600cts max, lined with 1 layer of 13mm flush jointed plasterboard.	
P5	Proprietary 2 Hour Fire Rated Plasterboard system - Line with 3 x13mm Fyrchek plasterboard. Full height to underside of floor slab above. Fire sealant to all junctions and abutting other surfaces. Install as per Manuf' system requirements.	
W1	150mm Thick Precast Concrete Panel Wall. Class 2 - Trowel Finish. Painted.	
W2	200mm Thick Precast Concrete Panel Wall. Class 2 - Trowel Finish. Painted.	
W3	150nm Steel Stud Partition System. Studs at 600 cts max. External - Fix 35mm furring channels to studwork and line with 9mm Fibre Cement Sheet with expressed joints. Painted. Internal - Line with 12mm Plywood. Internal Grade. Seal. Install Sarking behind FC sheet and R2.5 Insulation Batts to external walls.	
W4	390x190x90mm Concrete Blockwork in a running bond pattern. 10mm Cement Render to match adjacent piers. Painted: PNT1 - Surfmist.	
W5	EXTERNAL - Fix 35mm furring channels to fascia framing at 600 cts max. Line with 9mm Fibre Cement Sheet with expressed joints. Painted. REAR - Fix zincalume metal cladding (Fielders TL-5) to rear of fascia above roof level. Flash onto roofing.	
W6	EXTERNAL - Fix 35mm furring channels to substrate framing at 600 cts max. Line with 9mm Fibre Cement Sheet with expressed joints. Painted. Sarking between channels and substrate framing.	

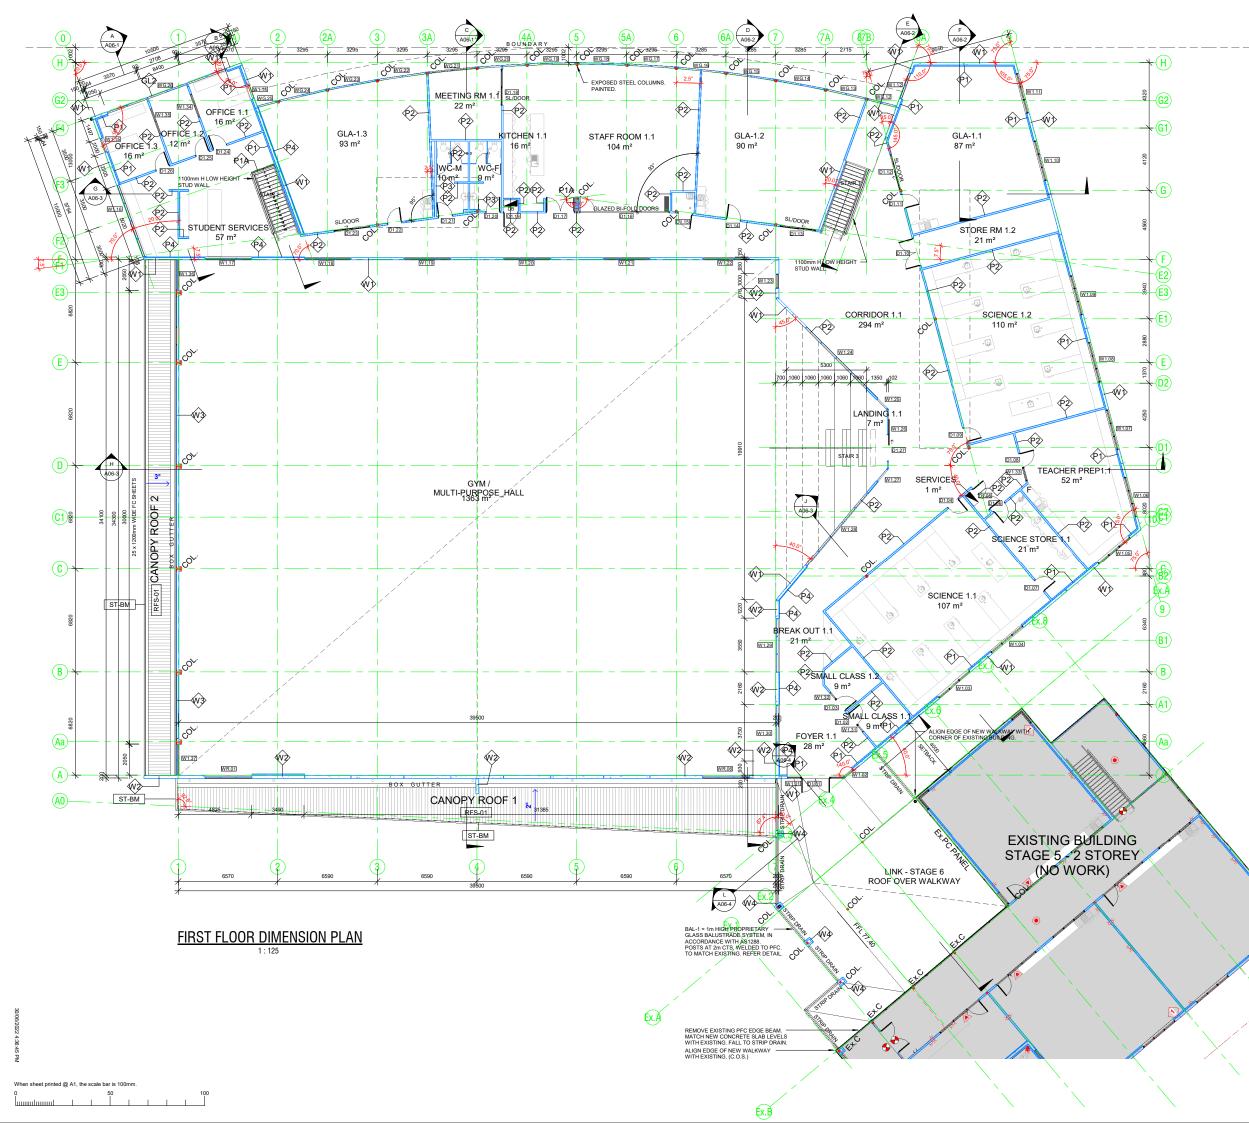NOTE:

Fire Resis with Spec

- with Specification C1.1 -120/120/T20 FRL to the load-and walls to the lower story -30/30/30 FRL to the floor bea or 1x13 Fyrchek
- :Floor slabs as Engineered
- :Load Bearing Columns 3x13 Fyrchek

NOTES:

All plasterboard sheeting to be stopped and flushed.

Where Hardiflex and Alucobond are us external wall cladding, provide a perme sarking membrane between furring cha and wall framing.

Air-cell insulbreak 80 or approved equivalent

Provide timber blocking in framing to take joinery and Handrails and Grabrails.



14 Boucaut Avenue, Blakeview. S.A. 5144

Drawing **FIRST FLOOR DIMENSION PLAN**




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Contractors must verify all dimensions at the jo before commencing work or making shop drawings.




0-FFL Ceiling Schedule		
Type Mark	Description	Area
	-	
СТ	1200 x 600 Mineral Fibre Tile (to match existing Building), in proprietary suspended ceiling grid system.	899 m²
FC	6mm FC Sheet with expressed joints. Fix to 35mm furring channels, fixed to substrate framing or proprietary external concealed suspended ceiling grid system for external applications with additional bracing to prevent uplift.	352 m²
NC	No Ceiling	269 m²
Grand total		1520 m²

FPB Ceiling Type 2700 Height Above Floor CT 1200 x 600 Selected Mineral Tiles on proprietary T-bar grid system. FPB 10mm flush jointed Plasterboard on concealed proprietary suspended grid system. MRPB 10mm Flush jointed Moisture Resistant Plasterboard on concealed proprietary suspended grid system. FR 2 Hour Fire Rated Ceiling system.	FPB Ceiling Type 2700 Height Above Floor CT 1200 x 600 Selected Mineral Tiles on proprietary T-bar grid system. FPB 10mm flush jointed Plasterbaard on concealed proprietary suspended grid system. MRPB 10mm Flush jointed Moisture Resistant Plasterbaard on concealed proprietary suspended grid system. FR 2 Hour Fire Rated Ceiling system. FC 9mm Fibre Cement Sheeting with expressed joints, fixed to substrate framing. EJ Express Joint CJ Control Joint NC No Ceiling - Underside of slab / exposed structure. RAK Raked Ceiling Access Panel. AP Proprietary Ceiling Access Panel. Manufacturers specifications. LIGHTING Splitfire Emergency Light 300x1200 Recessed LED Panel Maufacturers specifications. ELD ownlight Bathroom Exhaust Fan MECHANICAL Maufacture and the provestion and the provestion and the provestion and the provestion and the provestent and the provestent and the provestion			
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on concealed proprietary suspended grid system. MRPB 10mm Flush jointed Moisture Resistant Plasterboard on concealed proprietary suspended grid system. FR 2 Hour Fire Rated Ceiling system. 3 x 13mm layers of Fyrchek fixed to concealed proprietary suspended grid system. FC 9mm Fibre Cement Sheeting with expressed joints, fixed to substrate framing. EJ Express Joint CJ Control Joint NC No Ceiling - Underside of slab / exposed structure. RAK Raked Ceiling Access Panel. AP+LAD Proprietary Ceiling Access Panel. AP+LAD Proprietary Ceiling Access Panel. AP+LAD Proprietary Ceiling Access Panel. LiGHTING Bardic Exit Light Spitfire Emergency Light Co0x600 Recessed LED Panel Bathroom Exhaust Fan MECHANICAL Manufacturer Specifications.	on concealed proprietary suspended grid system. MRPB 10mm Flush jointed Moisture Resistant Plasterboard on concealed proprietary suspended grid system. FR 2 Hour Fire Rated Ceiling system. 3 x 13mm layers of Fyrchek fixed to concealed proprietary suspended grid system. FC 9mm Fibre Cement Sheeting with expressed joints, fixed to substrate framing. EJ Express Joint CJ Control Joint NC No Ceiling - Underside of slab / exposed structure. RAK Raked Ceiling or Eaves AP Proprietary Ceiling Access Panel. AP+LAD Proprietary Ceiling Access Panel. AP+LAD Proprietary Ceiling Access Panel. Lidder for roof access. Install to Manufacturers specifications. LIGHTING Bardic Exit Light Spitfire Emergency Light C 600x600 Recessed LED Panel Bathroom Exhaust Fan MECHANICAL Manufacture Spitfire Emergency Light Bathroom Exhaust Fan	СТ		
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expressed joints, fixed to substrate framing. EJ Express Joint CJ Control Joint NC No Ceiling - Underside of slab / exposed structure. RAK Raked Ceiling or Eaves AP Proprietary Ceiling Access Panel. AP+LAD Proprietary Ceiling Access Panel with Proprietary Pull Down Adder for roof access. Install to Manufacturers specifications. LIGHTING e Bardic Exit Light Spitfire Emergency Light Spitfire Emergency Light G00x600 Recessed ED Panel G00x600 Recessed Flourescent LEDO Recessed LED Downlight Bathroom Exhaust Fan MECHANICAL G00x600 Return Air Register G00x600 Return Air Register	expressed joints, fixed to substrate framing. EJ Express Joint CJ Control Joint NC No Ceiling - Underside of slab / exposed structure. RAK Raked Ceiling or Eaves AP Proprietary Ceiling Access Panel AP+LAD Proprietary Ceiling Access Panel with Proprietary Pull Down LIGHTING Bardic Exit Light Spitfire Emergency Light Spitfire Emergency Light G00x600 Recessed LED Panel G00x600 Recessed Flourescent LEDO Recessed LED Downlight Bathroom Exhaust Fan MECHANICAL G00x600 Return Air Register G00x600 Return Air Register	FR	3 x 13mm layers of Fyrchek fixed to concealed proprietary suspended	
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with Proprietary Pull Down Ladder for roof access. Install to Manufacturers specifications. LIGHTING Bardic Exit Light Spiffire Emergency Light 300x1200 Recessed LED Panel 600x600 Recessed Flourescent Bathroom Exhaust Fan MECHANICAL 600x600 Return Air Register 600x600 Return Air Register	with Proprietary Pull Down Ladder for roof access. Install to Manufacturers specifications. LIGHTING Bardic Exit Light Spitfire Emergency Light 300x1200 Recessed LED Panel 600x600 Recessed Flourescent Recessed LED Downlight Bathroom Exhaust Fan MECHANICAL 600x600 Return Air Register 600x600 Return Air Register	AP	Proprietary Ceiling Access Panel.	
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300x1200 Recessed LED Panel 600x600 Recessed Flourescent LED 0 Recessed LED Downlight Battroom Exhaust Fan MECHANICAL 600x600 Supply Air Register 600x600 Return Air Register	300x1200 Recessed LED Panel 600x600 Recessed Flourescent LED c Recessed LED Downlight Bathroom Exhaust Fan MECHANICAL 600x600 Supply Air Register 600x600 Return Air Register	•	Bardic Exit Light	
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LED 0 Recessed LED Downlight Bathroom Exhaust Fan MECHANICAL 600x600 Supply Air Register 600x600 Return Air Register	LED 0. Recessed LED Downlight Bathroom Exhaust Fan MECHANICAL 600x600 Supply Air Register 600x600 Return Air Register			
Bathroom Exhaust Fan MECHANICAL 600x600 Supply Air Register 600x600 Return Air Register	Bathroom Exhaust Fan MECHANICAL 600x600 Supply Air Register 600x600 Return Air Register	\square	600x600 Recessed Flourescent	
MECHANICAL 600x600 Supply Air Register 600x600 Return Air Register	MECHANICAL 600x600 Supply Air Register 600x600 Return Air Register	LED O	Recessed LED Downlight	
600x600 Supply Air Register 600x600 Return Air Register	600x600 Supply Air Register 600x600 Return Air Register	8	Bathroom Exhaust Fan	
600x600 Return Air Register	600x600 Return Air Register	MECHANICAL		
		\square	600x600 Supply Air Register	
1200x600 Return Air Register			600x600 Return Air Register	
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300x300 Fresh Air Register	300x300 Fresh Air Register	⊞	300x300 Fresh Air Register	

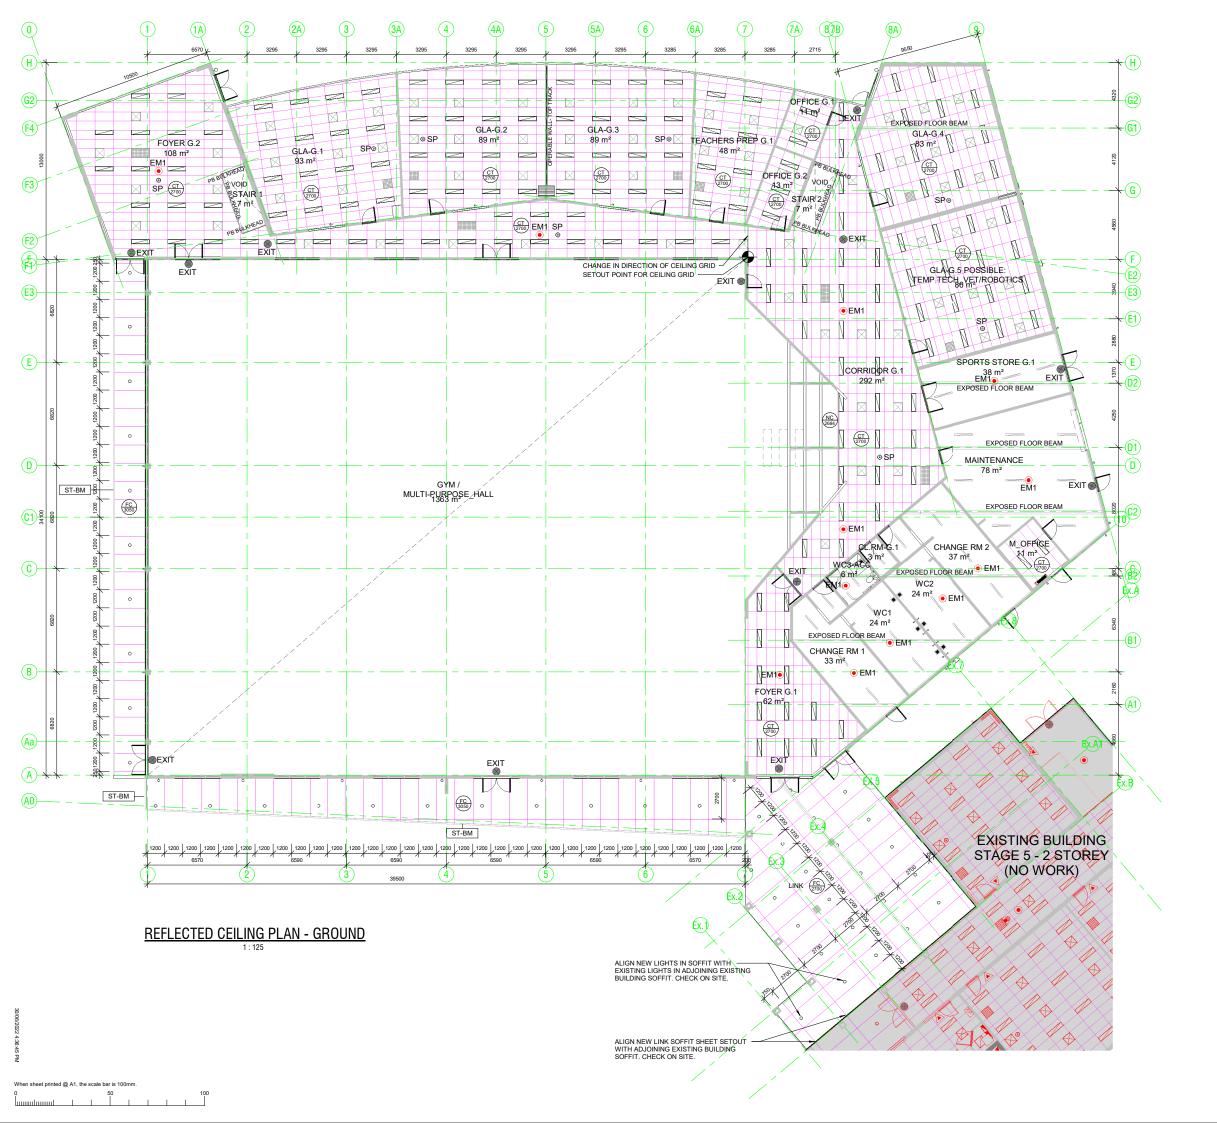
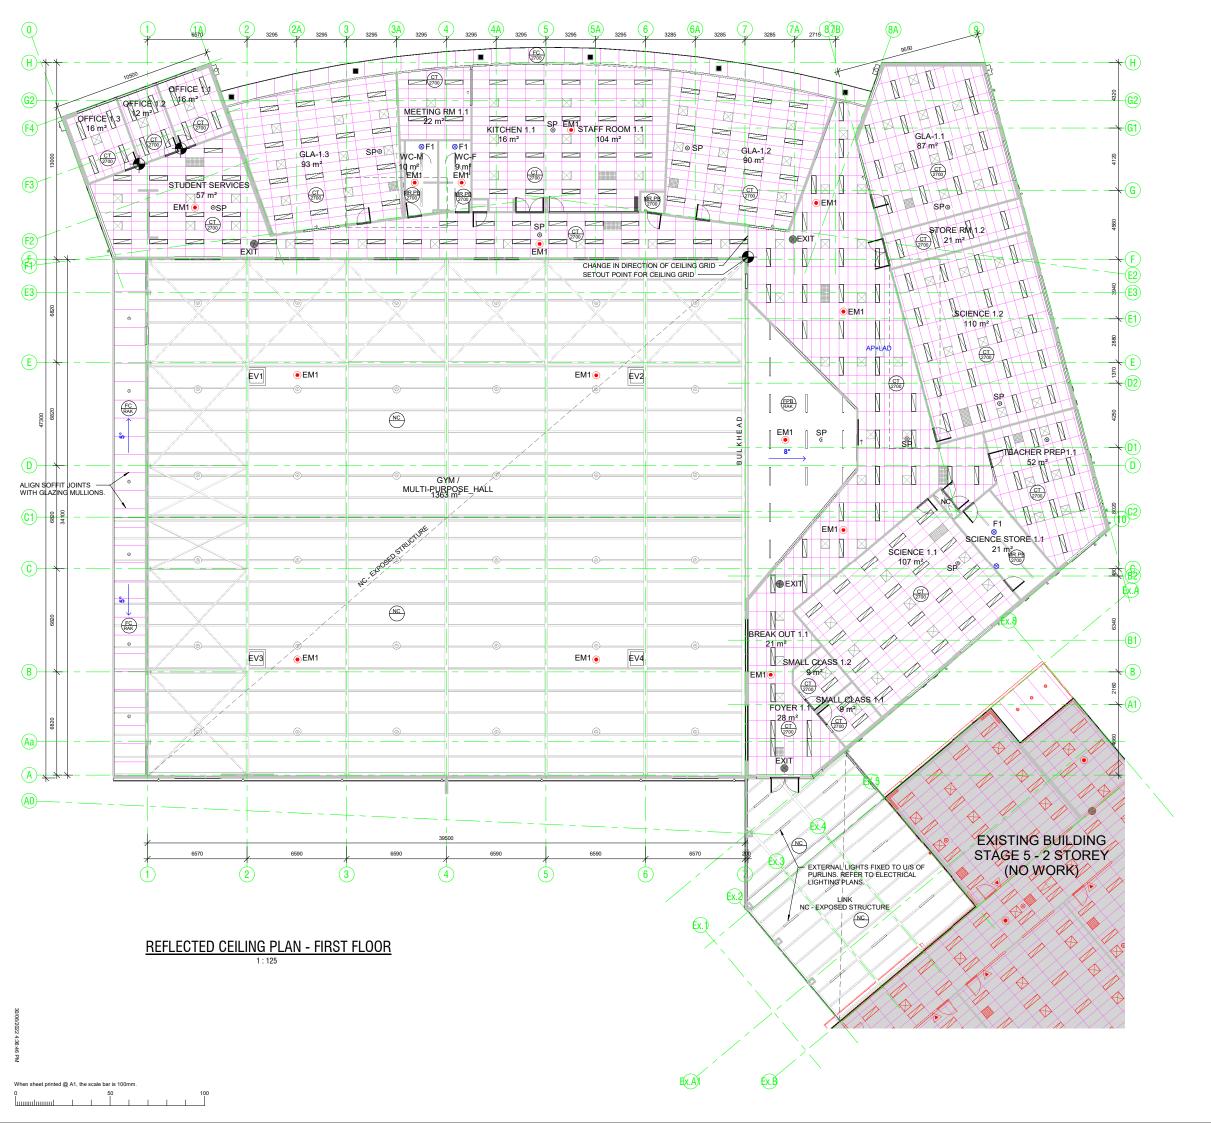
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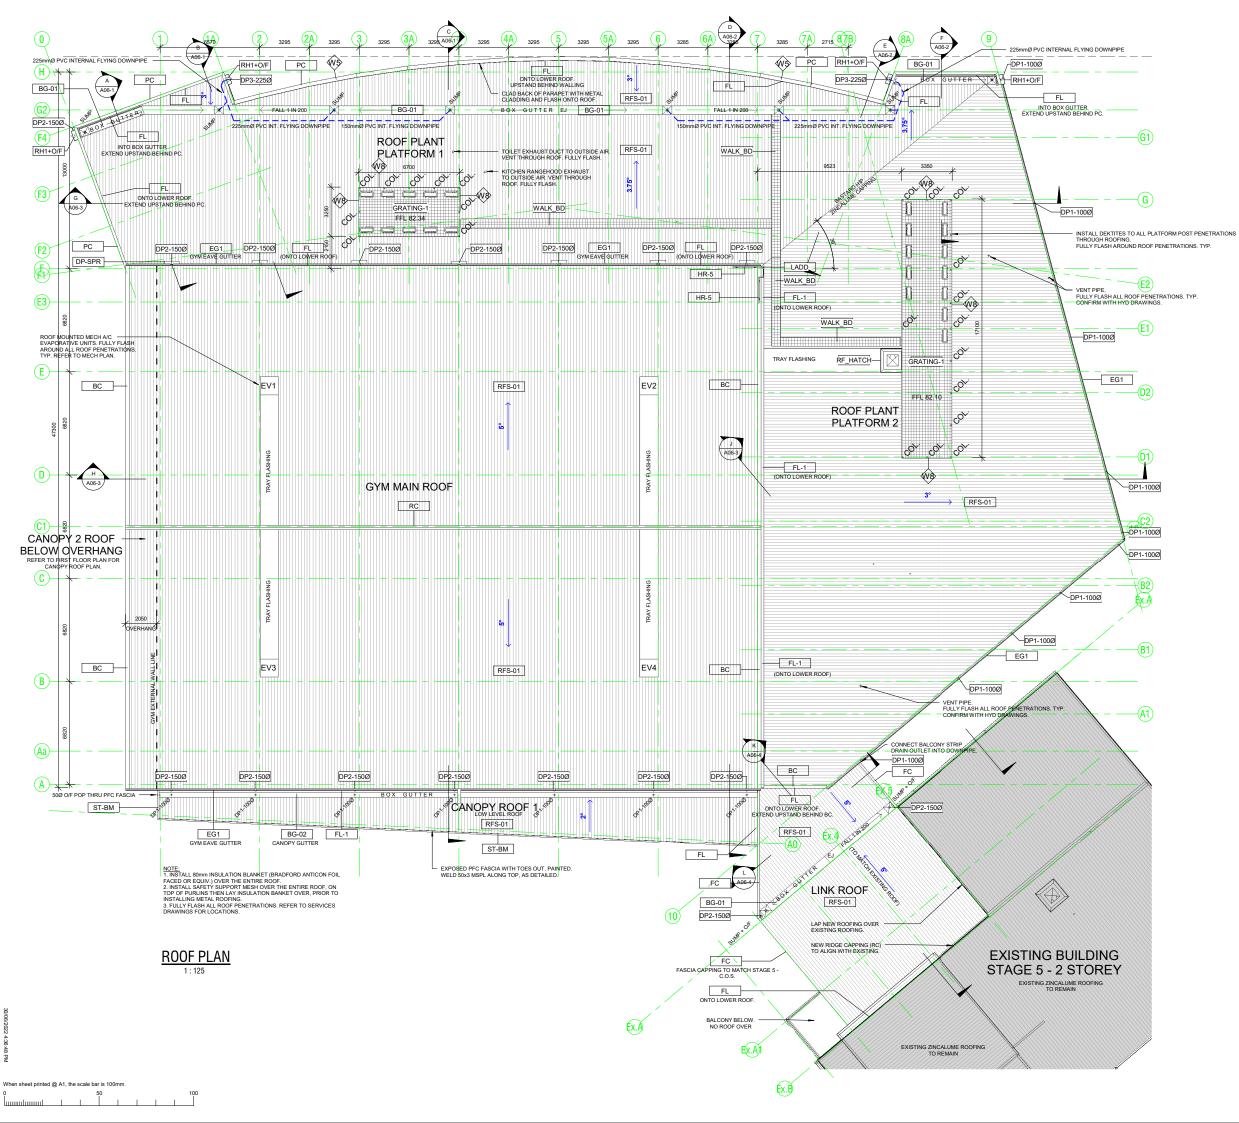
1-FFL Ceiling Schedule			
Type Mark	Description	Area	
СТ	1200 x 600 Mineral Fibre Tile (to match existing Building), in proprietary suspended ceiling grid system.	1087 m²	
FC	6mm FC Sheet with expressed joints. Fix to 35mm furring channels, fixed to substrate framing or proprietary external concealed suspended ceiling grid system for external applications with additional bracing to prevent uplift.	42 m²	
FPB	Flush Plasterboard	84 m²	
MR.PB	10mm Flush jointed Moisture Resistant Plasterboard on concealed proprietary suspended grid system.	42 m²	
NC	No Ceiling	159 m²	
Grand total		1414 m²	

CEILING LEGEND		
FPB Ceiling Type		
2700	Height Above Floor	
CT FPB	1200 x 600 Selected Mineral Tiles on proprietary T-bar grid system. 10mm flush jointed Plasterboard	
	on concealed proprietary suspended grid system.	
MRPB	10mm Flush jointed Moisture Resistant Plasterboard on concealed proprietary suspended grid system.	
FR	2 Hour Fire Rated Ceiling system. 3 x 13mm layers of Fyrchek fixed to concealed proprietary suspended grid system.	
FC	9mm Fibre Cement Sheeting with expressed joints, fixed to substrate framing.	
EJ	Express Joint	
CJ	Control Joint	
NC	No Ceiling - Underside of slab / exposed structure.	
RAK	Raked Ceiling or Eaves	
AP	Proprietary Ceiling Access Panel.	
AP+LAI	Proprietary Ceiling Access Panel with Proprietary Pull Down Ladder for roof access. Install to Manufacturers specifications.	
LIGHTI	NG	
	Bardic Exit Light	
	Spitfire Emergency Light	
	300x1200 Recessed LED Panel 600x600 Recessed Flourescent	
	Recessed LED Downlight	
LED Q	Bathroom Exhaust Fan	
MECHA	ANICAL	
	600x600 Supply Air Register	
	600x600 Return Air Register	
	1200x600 Return Air Register	
⊞	300x300 Fresh Air Register	



for Construction until approved by Statutory Authorities before

commencing work or making shop drawings.



ROOF NOTES

1. THE ROOFING CONTRACTOR IS SOLELY RESPONSIBLE FOR THE WATER-TIGHTNESS OF THE ROOF.

2. ENSURE ROOF SYSTEM INCLUDING GUTTERS, DOWNPIPES AND FLASHINGS ARE WITHOUT DEFECTS OR WATER LEAKS AND IS TO AUSTRALIAN STANDARD ALSO THAT THE ROOF AREA IS CLEANED DOWN FREE OF DEBRIS. AT ALL TIMES VERY FRECAUTION TO BE TAKEN TO PREVENT RUBBISH ENTERING DOWNPIPES. ROOF & GUTTERS MUST HAVE ALL DEBRIS INCLUDING POP. FUTURE TSHANKS REMOVED AND BE CLEANED ONE (1) ERCH SEANDA OVER & AGAIN ON COMPLETION OF DEFECTS.

3. DOWNPIPES ARE TO BE FULLY HYDRAULICALLY SEALED BETWEEN RAINWATER HEAD/SUMP AND BELOW-GROUND DRAIN. CONNECT ALL DOWNPIPES INTO IN-GROUND STORMWATER SYSTEM AS DETAILED IN CIVIL AND HYDRAULIC DOCUMENTS.

4. ALL ROOFING IS TO BE INSTALLED IN STRICT ACCORDANCE WITH THE MANUFACTURER'S INSTRUCTIONS. ALL ROOFING IS TO BE INSTALLED IN STRICT ACCORDANCE WITH AS 1397-1993 AND AS/NZS 1562

5. REFER TO MECHANICAL DRAWINGS FOR DETAILS OF AIR CONDITIONING & EXHAUST UNITS.

6. ALLOW FOR CUTTING AND FLASHING OF ALL ROOF PENETRATIONS. CO-ORDINATE WITH SERVICE DOCUMENTATION FOR RISER, DUCTS, VENT STACKS etc. ENSURE THAT SERVICE PENETRATIONS DO NOT CLASH WITH ROOF PLANT EQUIPMENT, PLATFORMS & GUTTERS, FLASHINGS. PROVIDE CONTINUOUS TRAY FLASHINGS (FT FROM LARGE MECHANICAL PENETRATIONS TO THE RIDGE OR HIGHEST POINT ON ROOF.

7. PROVIDE BRACING / STRUCTURAL TRIMMERS FOR PENETRATIONS TO SUPPORT ROOF SHEET AND PLANT EQUIPMENT AS REQUIRED.

8. REFER TO MECHANICAL DRAWINGS FOR PACKAGED A/C UNITS. THE CONTRACTOR SHALL CONFIRM SIZE OF STRUCTURAL PLATFORM, PRIOR TO ORDERING A/C UNITS.

9. PROVIDE DEKTITE FLASHING OR SIMILAR APPROVED AROUND STEEL SUPPORT TO ENSURE WATER TIGHT SEAL AROUND PENETRATIONS. ALLOW FOR MOVEMENT.

ANDIAR PENE INTINGS ALLOIF TON INDEPENENT 10. ACCESS TO AND SCALE FROM ROOF LEVELS MUST BE PROVIDED IN FULL COMPLIANCE WITH THE B.C.A. INCC ALLOWANCE MUST BE MADE FOR FALL PROTECTION SAFETY SYSTEMS ON ALL ROOFS WHERE CONVENTIONAL HANDRAILS, PARAPETS are DO NOT EXIST. SYSTEM TO BE DESIGNED & INSTALLED BY SAFETY EQUIPMENT MANUFACTURER OR APPROVED INSTALLER ACCESS POINTS NOMINATED ON ROOF PLAN ARE NDICATIVE ONLY BUILDER TO IN STALL TIE OF POINTS' TO CANOPY FASCIAS IN ACCORDANCE WITH ROOF ACCESS SAFETY CONSULTANTS DESIGN.

11. NEW ROOFING TYPE / PROFILE AND COLOUR TO MATCH EXISTING ADJOINING BUILDING. ZINCLAUME.

12. ALL VISIBLE CAPPINGS / FLASHING TO BE COLORBOND TO MATCH EXISTING BUILDING.

Tag .	Description .	
BC	Barge capping Colorbond Surfmist to match existing adjoining Building.	
BG-01	600 W x 150mm Deep Box gutter folded from 0.8mm zincalume sheeting. Spandek gutter board on adjustable box gutter support straps at 900 cts max. 1 in 200 Fall to sumps.	
BG-02	300 W x 75mm Deep Box gutter folded from 0.8mm zincalume sheeting. 30x0.8mm Galv support straps at 900 cts max. 1 in 200 Fall to sumps.	
DP1-100Ø	100 Dia.PVC Downpipe. Connect to in-ground storwater system. Painted: Colorbond Surfmist	
DP2-150Ø	150 Dia.PVC Downpipe. Connect to in-ground storwater system. Painted: Colorbond Surfmist	
DP3-225Ø	225 Dia.PVC Downpipe. Connect to in-ground storwater system. Painted: Colorbond Surfmist	
DP-SPR	Downpipe Spreader onto lower roof. Same size as downpipe.	
EG1	Fieders "Urbis" Eaves Gutter. Colorbond Surfmist to match existing adjoining Building.	
FC	Fascia capping Colorbond Surfmist to match existing adjoining Building.	
FL	Flashing. Colorbond Surmist where visible. Zincalume where not visible.	
FL-1	Flashing Colorbond to match existing adjoining Building. Colour: Surfmist.	
GRATING-1	Selected Galv. floor grating system fixed to structural steel framing / joist with proprietary fixings.	
HR-5	Proprietry Galv.Handrail & Balustrade system. Handrail 1000mm above F.F.L. (Monowills or Moddex)	
LADD	Galv.Ladder to be designed and installed in accordance with AS1657.	
PC	Parapet wall capping Colorbond to match existing adjoining Building. Colour: Surfmist.	
RC	Ridge capping Zincalume to match Roofing.	
RF_HATCH	Proprietary roof access hatch system with pull down ladder. Install apron flashing.	
RFS-01	Fielders TL-5 Zincalume Metal roof cladding, to match existing adjoining Building.	
RH1+O/F	Colorbond rainhead with overflow pop.Width to suit box gutter.	
ST-BM	Structural Steel Framing (Beam / Rafter / Window Head), as per Struct.Eng.Design.	
WALK BD	Proprietary Walkboard system, fixed to roofing in accordance with Manuf details.	

4	Issued for Building Rules Consent	30/06/22
3	Updated Plans	28/06/22
2	Updated Plans	06/06/22
1	Updated Plans	23/05/22
Issu	e Amendments	Date
Pro	ect	
BCCC Stage 6 - Gym + GLA		
14 Boucaut Avenue, Blakeview. S.A.		

5144

Drawing **ROOF PLAN**



16-22 Erudina Ave, Edwardstown S.A. 5039 Ph (08) 8277 0111 Fax(08) 8277 2255 Commercial - Industrial - Domestc Date : 23/05/22




© COPYRIGHT Drawing Number : A04-1.4



Elevation 3 - West 1:100

When sheet printed @ A1, the scale bar is 100mm.

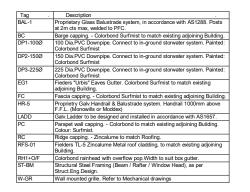humburund



Wall Type	
W1	150 Pair
W2	200 Pair
W3	150 35n She Inte Insu
W4	390 Cer
W5	EXT max RE/ abo
W6	EX1 max Sar

Wall Schedule - External	
Description	
nm Thick Precast Concrete Panel Wall. Class 2 - Trowel Finish. ted.	
nm Thick Precast Concrete Panel Wall. Class 2 - Trowel Finish. ted.	
mm Steel Stud Partition System. Studs at 600 cts max. External - 1 m furring channels to studwork and line with 9mm Fibre Cement at with expressed joints. Painted. Internal - Line with 12mm Plywoot nal Grade. Seal. Install Sarking behind FC sheet and R2.5 ation Batts to external walls.	
(190x90mm Concrete Blockwork in a running bond pattern. 10mm ent Render to match adjacent piers. Painted: PNT1 - Surfmist.	
ERNAL - Fix 35mm furring channels to fascia framing at 600 cts. Line with 9mm Fibre Cement Sheet with expressed joints. Painte IR - Fix zincalume metal cladding (Fielders TL-5) to rear of fascia re roof level. Flash onto roofing.	d.
ERNAL - Fix 35mm furring channels to substrate framing at 600 cl . Line with 9mm Fibre Cement Sheet with expressed joints. Painte ing between channels and substrate framing.	

4	Issued for Building Rules Consent	30/06/22	
3	Updated Plans	28/06/22	
2	Updated Plans	06/06/22	
1	Updated Plans	23/05/22	
Issue	Amendments	Date	
Proje	Project		
BC	BCCC Stage 6 - Gym + GLA		

14 Boucaut Avenue, Blakeview. S.A. 5144

Drawing **ELEVATION SHEET 1** - OVERALL




16-22 Erudina Ave, Edwardstown S.A. 5039 Ph. (08) 8277 0111 Fax(08) 8277 2255 Commercial - Industrial - Domestc Date : 23/05/22 Drawn :

Scale: 1:100 (@ A1) or (@ A3) Project Number : 0419

© COPYRIGHT Drawing Number : A05-1.4

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Elevation 2 - South 1:100

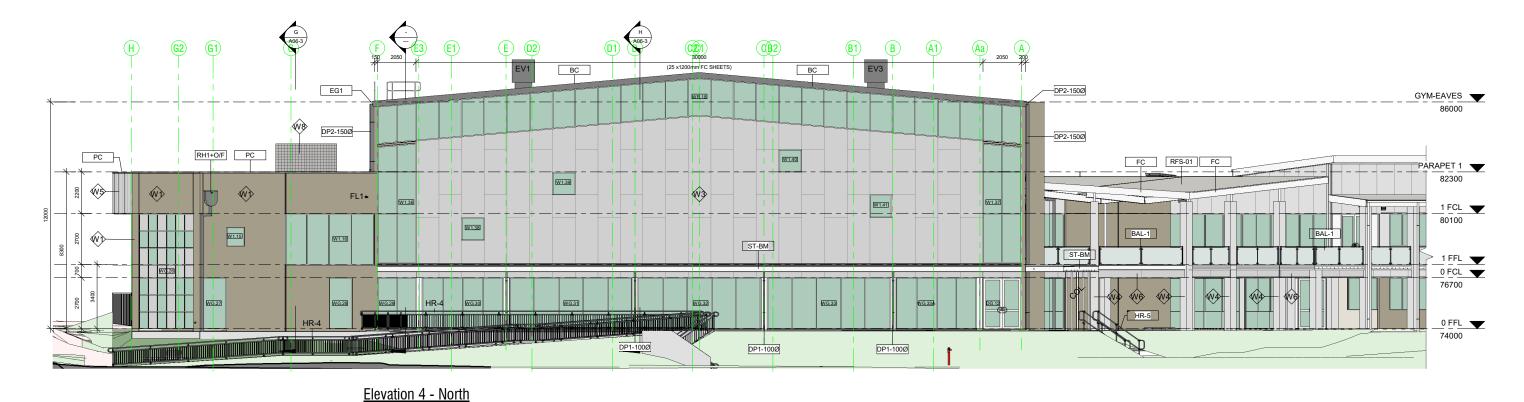Tag	. Description .	
BAL-1	Proprietary Glass Balustrade system, in accordance with AS1288. Posts at 2m cts max, welded to PFC.	
BC	Barge capping Colorbond Surfmist to match existing adjoining Building.	
DP1-100Ø	100 Dia.PVC Downpipe. Connect to in-ground storwater system. Painted: Colorbond Surfmist	
DP2-150Ø	150 Dia.PVC Downpipe. Connect to in-ground storwater system. Painted: Colorbond Surfmist	
EG1	Fieders "Urbis" Eaves Gutter. Colorbond Surfmist to match existing adjoining Building.	
FC	Fascia capping Colorbond Surfmist to match existing adjoining Building.	
HR-5	Proprietry Galv.Handrail & Balustrade system. Handrail 1000mm above F.F.L. (Monowills or Moddex)	
LADD	Galv.Ladder to be designed and installed in accordance with AS1657.	
PC	Parapet wall capping Colorbond to match existing adjoining Building. Colour: Surfmist.	
RFS-01	Fielders TL-5 Zincalume Metal roof cladding, to match existing adjoining Building.	
RH1+O/F	Colorbond rainhead with overflow pop.Width to suit box gutter.	
ST-BM	Structural Steel Framing (Beam / Rafter / Window Head), as per Struct.Eng.Design.	
W-GR	Wall mounted grille. Refer to Mechanical drawings	

W3

Wall Schedule - Exter	nal
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 Wall Type
 Description

 W1
 150mm Thick Precast Concrete Panel Wall. Class 2 - Trowel Finish. Painted.

 W2
 200mm Thick Precast Concrete Panel Wall. Class 2 - Trowel Finish.

200mm Thick Precast Concrete Panel Wall. Class 2 - Trowel Finish. Painted. 150mm Steel Stud Partition System. Studs at 600 cts max. External - Fix 35mm furring channels to studwork and line with 9mm Fibre Cement Sheet with expressed joints. Painted. Internal - Line with 12mm Plywood. Internal Grade. Seal. Install Sarking behind FC sheet and R2.5 Insulation Batts to external walls.

W4 390x190x90mm Concrete Blockwork in a running bond pattern. 10mm Cement Render to match adjacent piers. Painted: PNT1 - Surfmist.

Cernent Render to match adjacent piers. Painted: PNT1 - Surfmist. W5 EXTERNAL - Fix 35mm furring channels to fascia framing at 600 cts max. Line with 9mm Fibre Cernent Sheet with expressed joints. Painted. REAR - Fix zincalume metal cladding (Fielders TL-5) to rear of fascia above roof level. Flash onto roofing. W6 EXTERNAL - Fix 35mm furring channels to substrate framing at 600 cts max. Line with 9mm Fibre Cernent Sheet with expressed joints. Painted. Sarking between channels and substrate framing.

4	Issued for Building Rules Consent	30/06/22	
3	Updated Plans	28/06/22	
2	Updated Plans	06/06/22	
1	Updated Plans	23/05/22	
Issu	e Amendments	Date	
Proj	Project		
BCCC Stage 6 - Gym + GLA			

14 Boucaut Avenue, Blakeview. S.A. 5144

Drawing **ELEVATION SHEET 2** - OVERALL



16-22 Erudina Ave, Edwardstown S.A. 5039 Ph (08) 8277 0111 Fax(08) 8277 2255 Commercial - Industrial - Domestc Date : 23/05/22 Drawn :

Scale: 1:100 (@ A1) or (@ A3) Project Number : 0419

© COPYRIGHT Drawing Number : A05-2.4


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1

(1) Part Elevation 1 - South West 1 . 100



Tag	. Description .
BAL-1	Proprietary Glass Balustrade system, in accordance with AS1288. Posts at 2m cts max, welded to PFC.
BC	Barge capping Colorbond Surfmist to match existing adjoining Building.
DP1-100Ø	100 Dia.PVC Downpipe. Connect to in-ground storwater system. Painted: Colorbond Surfmist
DP2-150Ø	150 Dia.PVC Downpipe. Connect to in-ground storwater system. Painted: Colorbond Surfmist
EG1	Fieders "Urbis" Eaves Gutter. Colorbond Surfmist to match existing adjoining Building.
PC	Parapet wall capping Colorbond to match existing adjoining Building. Colour: Surfmist.
RC	Ridge capping Zincalume to match Roofing.
RFS-01	Fielders TL-5 Zincalume Metal roof cladding, to match existing adjoining Building.
RH1+O/F	Colorbond rainhead with overflow pop.Width to suit box gutter.
SS-3	New Suspended Concrete Slab, as per Struct.Eng.Design.
ST-BM	Structural Steel Framing (Beam / Rafter / Window Head), as per Struct.Eng.Design.
W-GR	Wall mounted grille. Refer to Mechanical drawings

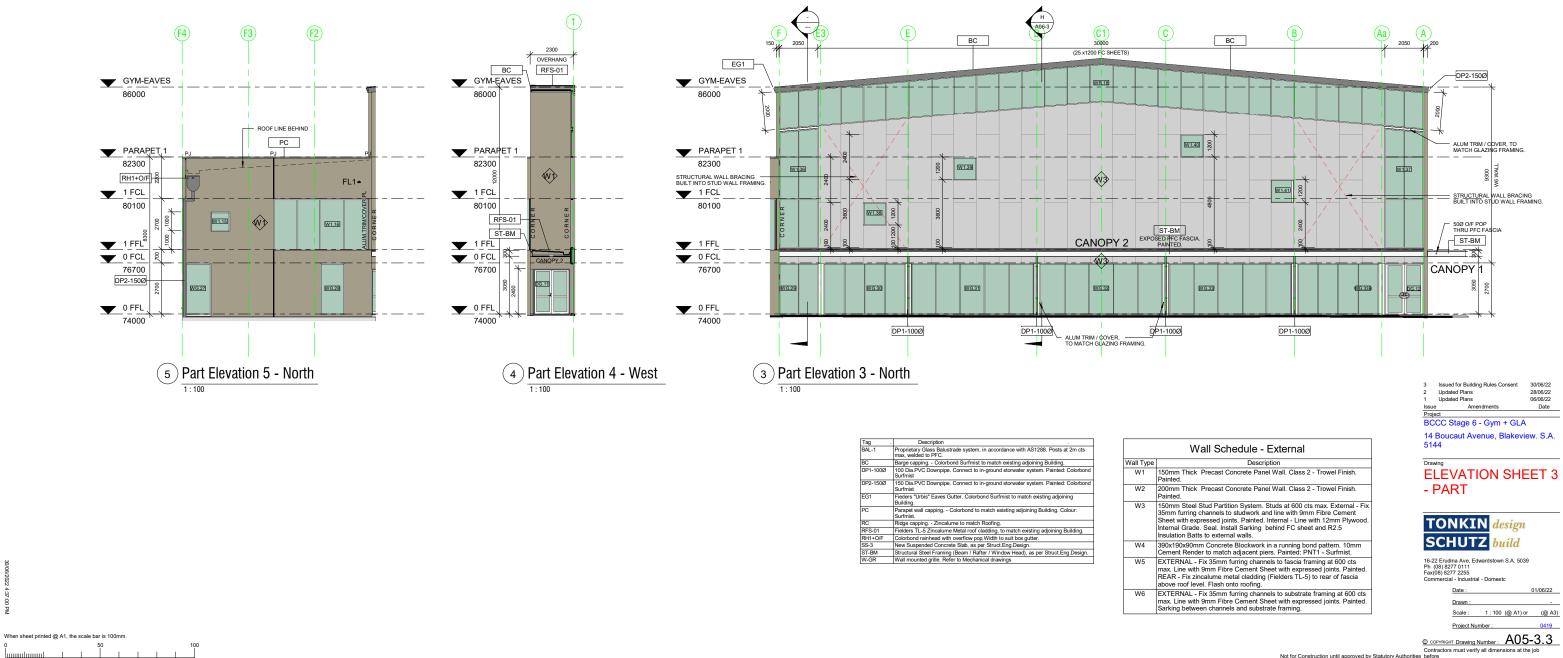Contractors must verify all dimensions at the jo before commencing work or making shop drawings. Not for Construction until approved by Statute




Wall Schedule - External		
Wall Type	Description	
W1	150mm Thick Precast Concrete Panel Wall. Class 2 - Trowel Finish. Painted.	
W2	200mm Thick Precast Concrete Panel Wall. Class 2 - Trowel Finish. Painted.	
W3	150mm Steel Stud Partition System. Studs at 600 cts max. External - Fix 36mm furring channels to studwork and line with 9mm Fibre Cement Sheet with expressed joints. Painted. Internal - Line with 12mm Plywood. Internal Grade. Seal. Install Sarking behind FC sheet and R2.5 Insulation Batts to external walls.	
W4	390x190x90mm Concrete Blockwork in a running bond pattern. 10mm Cement Render to match adjacent piers. Painted: PNT1 - Surfmist.	
W5	EXTERNAL - Fix 35mm furring channels to fascia framing at 600 cts max. Line with 9mm Fibre Cement Sheet with expressed joints. Painted. REAR - Fix zincalume metal cladding (Fielders TL-5) to rear of fascia above roof level. Flash onto roofing.	
W6	EXTERNAL - Fix 35mm furring channels to substrate framing at 600 cts max. Line with 9mm Fibre Cement Sheet with expressed joints. Painted. Sarking between channels and substrate framing.	


Tag .	Description .
AL-TRIM	Aluminium Trim / Cover Plate, to match glazing framing.
ALUM.TRIM	
BAL-1	Proprietary Glass Balustrade system, in accordance with AS1288. Posts at 2m cts max, welded to PFC.
DP1-100Ø	100 Dia.PVC Downpipe. Connect to in-ground storwater system. Painted: Colorbond Surfmist
DP3-225Ø	225 Dia.PVC Downpipe. Connect to in-ground storwater system. Painted: Colorbond Surfmist
EG1	Fieders "Urbis" Eaves Gutter. Colorbond Surfmist to match existing adjoining Building.
FC	Fascia capping Colorbond Surfmist to match existing adjoining Building.
PC	Parapet wall capping Colorbond to match existing adjoining Building. Colour: Surfmist.
RFS-01	Fielders TL-5 Zincalume Metal roof cladding, to match existing adjoining Building.
RH1+O/F	Colorbond rainhead with overflow pop. Width to suit box gutter.
ST-BM	Structural Steel Framing (Beam / Rafter / Window Head), as per Struct.Eng.Design.
W-GR	Wall mounted grille. Refer to Mechanical drawings

2	Issued for Building Rules Consent Updated Plans	28/06/22
1	Updated Plans	06/06/22
Issue	Amendments	Date
Proje	ct	

Date :		01/06/22
Drawn :		-
Scale :	1:100 (@ A1) or	(@ A3
Project Nu	imber :	0419

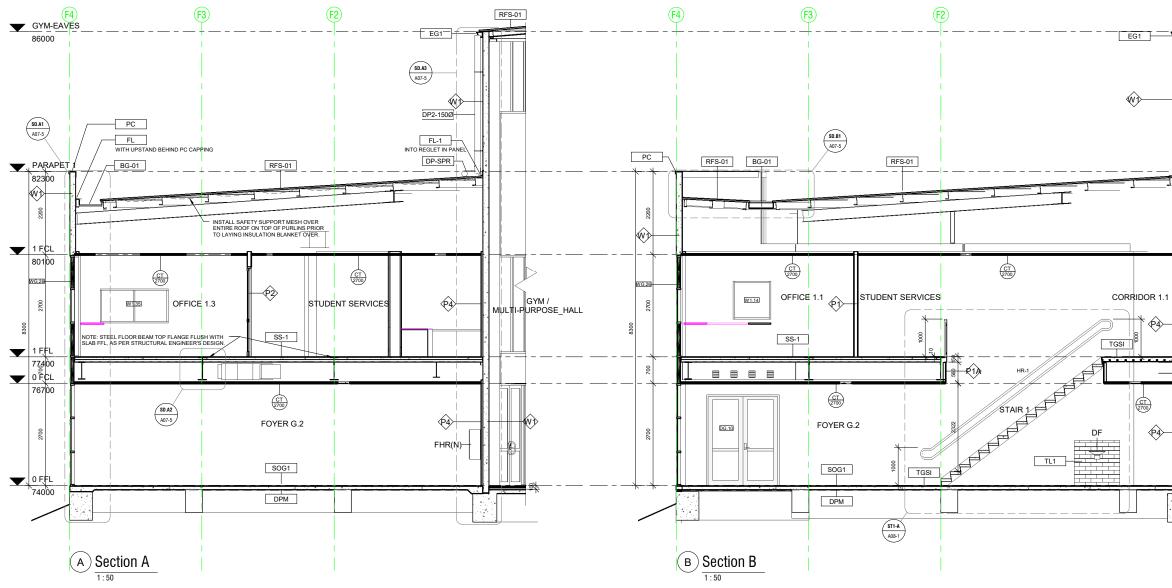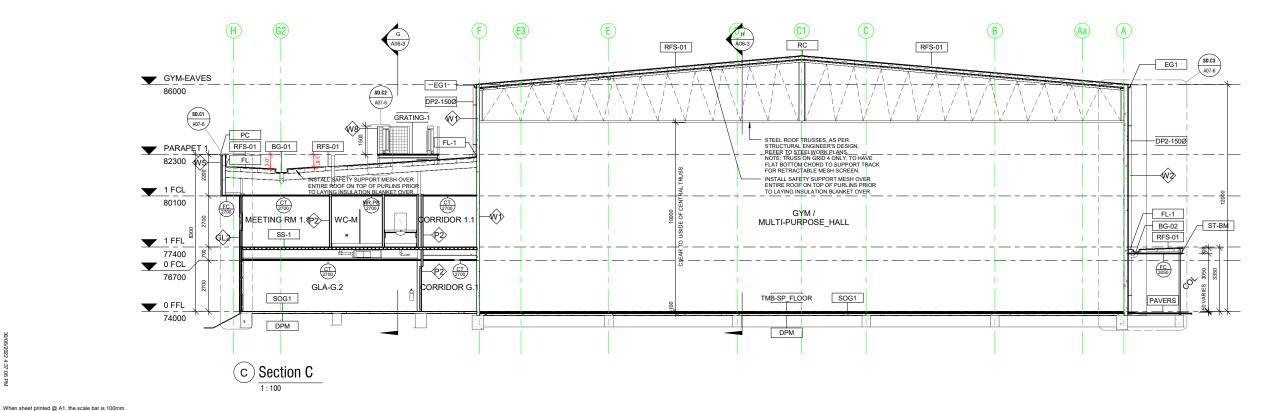Contractors must verify all dimensions at the j before commencing work or making shop drawings.





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		RFS-01	[
- ť	ī			Wall Schedule
	2		Wall Type	Description
			P1	INTERNAL - 64mm Steel stud partition system. Studs @ 600cts max. 20mm Airgap against panel. Line internally with 1 layer 13mm flush jointed plasterboard. Moisture resistant P/board to all wet areas with studs @ 450 cts max. R2.5 Insulation batts to all external walls.
				INTERNAL - 64mm Steel stud partition system. Studs @ 600cts max lined internally with 1 layer of 13mm flush jointed plasterboard.
			P1B	INTERNAL - 64mm Steel stud partition system. Studs @ 600cts max lined internally with 1 layer of 12mm Plywood. Internal grade. Sealed.
				INTERNAL - 92mm Steel stud partition system. Studs @ 600cts max to underside of slab or structure above. Line with 1 layer 13mm flush jointed Plasterboard both sides. Moisture resistant P/board to all wet areas with 92mm stud @ 450cts max. R1.5 Insulation Batts to all internal walls. Typ.
Ţ		+	_	INTERNAL - 92mm Steel stud partition system. Studs @ 600cts max to underside of slab or structure above. Line with 1 layer 13mm flush jointed Plasterboard to one side only. Moisture resistant P/board to all wet areas with 92mm stud @ 450cts max. R1.5 Insulation
			P4	INTERNAL - 35mm Furring Channel @ 600cts max, lined with 1 layer of 13mm flush jointed plasterboard.
				Proprietary 2 Hour Fire Rated Plasterboard system - Line with 3 x13mm Fyrchek plasterboard. Full height to underside of floor slab above. Fire sealant to all junctions and abutting other surfaces. Install as per Manuf system requirements.
	4			150mm Thick Precast Concrete Panel Wall. Class 2 - Trowel Finish. Painted.
				200mm Thick Precast Concrete Panel Wall. Class 2 - Trowel Finish. Painted.
1		GYM/		150mm Steel Stud Partition System. Studs at 600 cts max. External - Fix 35mm furring channels to studwork and line with 9mm Fibre Cernent Sheet with expressed joints. Painted. Internal - Line with 12mm Plywood. Internal Grade. Seal. Install Sarking behind FC sheet and R2.5 Insulation Batts to external walls.
		MULTI-PURPOSE_HALL	W4	390x190x90mm Concrete Blockwork in a running bond pattern. 10mm Cement Render to match adjacent piers. Painted: PNT1 - Surfmist.
	1		W5	EXTERNAL - Fix 35mm furring channels to fascia framing at 600 cts max. Line with 9mm Fibre Cement Sheet with expressed joints. Painted. REAR - Fix zincalume metal cladding (Fielders TL-5) to rear of fascia above roof level. Flash onto roofing.
L.a.Ì				EXTERNAL - Fix 35mm furring channels to substrate framing at 600 cts max. Line with 9mm Fibre Cement Sheet with expressed joints. Painted. Sarking between channels and substrate framing.
			Тад	. Description .
	2 2 2		BG-01	600 W x 150mm Deep Box gutter folded from 0.8mm zincalume sheeting. Spandek gutter board on adjustable box gutter support straps at 900 cts max. 1 in 200 Fall to sumps.
		TMB-SP_FLOOR	BG-02 DP2-150Ø	300 W x 75mm Deep Box guiter folded from 0.8mm zincalume sheeting. 30x0.8mm Galv support straps at 900 cts max. 1 in 200 Fall to sumps. 150 Dia.PVC Downpipe. Connect to in-ground storwater system. Painted: Colorbond
			DP-SPR	Surfmist Downpipe Spreader onto lower roof. Same size as downpipe.
-			DPM	Damp proof membrane
4	17		EG1	Fieders "Urbis" Eaves Gutter. Colorbond Surfmist to match existing adjoining Building.
Ŀ	2	DPM	FL	Flashing. Colorbond Surmist where visible. Zincalume where not visible.
10-	1	i	FL-1	Flashing Colorbond to match existing adjoining Building. Colour: Surfmist.
Ľ	. ·		GRATING-1	Selected Galv. floor grating system fixed to structural steel framing / joist with
			L	proprietary fixings.

	Selected segmented pavers on sand sub-base, to match existing pavers. Fall away from building.
c	Parapet wall capping Colorbond to match existing adjoining Building. Colour: Surfmist.
RC .	Ridge capping Zincalume to match Roofing.
FS-01	Fielders TL-5 Zincalume Metal roof cladding, to match existing adjoining Building.
iOG1	New Concrete Slab / Footing on ground, as per Struct.Eng.Design.
iS-1	New Suspended Concrete Slab, as per Struct.Eng.Design.
T-BM	Structural Steel Framing (Beam / Rafter / Window Head), as per Struct.Eng.Design.
GSI	Tactile Ground Surface Indicator of 30% contrasting colour, in accordance with AS1428.
Լ1	Selected non-slip ceramic floor tiles - Type 1.
	Proprietary timber sprung sports flooring system, as per Flooring Contractors design. Allow 100mm setdown to concrete floor slab.

proprietary fixings. Selected segmented pavers on sand sub-base, to match existing

1 Issue	Updated Plans Amendments	23/05/22 Date
2	Updated Plans	06/06/22
3	Updated Plans	28/06/22
4	Issued for Building Rules Consent	30/06/22

14 Boucaut Avenue, Blakeview. S.A. 5144

Drawing SECTION SHEET 1





16-22 Erudina Ave, Edwardstown S.A. 5039 Ph (08) 8277 0111 Fax(08) 8277 2255 Commercial - Industrial - Domestc Date :



© COPYRIGHT Drawing Number : A06-1.4

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When sheet printed @ A1, the scale bar is 100mm.

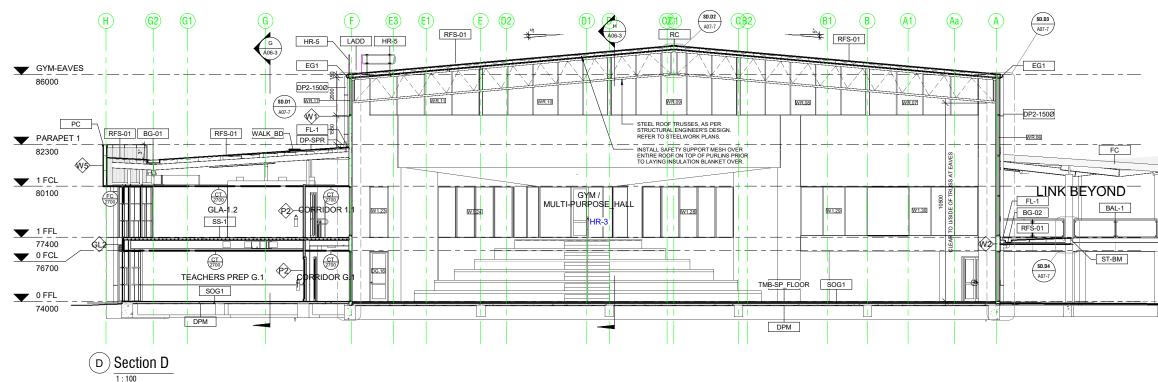

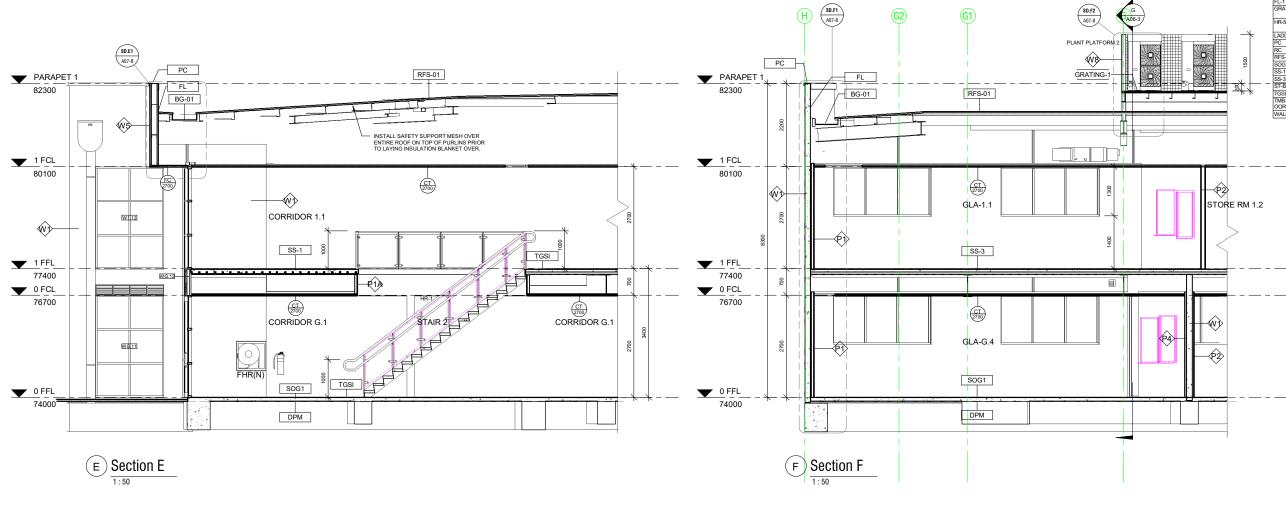	Wall Schedule
Wall Type	Description
P1	INTERNAL - 64mm Steel stud partition system. Studs @ 600cts max. 20mm Airgap against panel. Line internally with 1 layer 13mm flush jointed plasterboard. Moisture resistant Pi/board to all wet areas with studs @ 450 cts max. R2.5 Insulation batts to all external walls.
P1A	INTERNAL - 64mm Steel stud partition system. Studs @ 600cts max lined internally with 1 layer of 13mm flush jointed plasterboard.
P1B	INTERNAL - 64mm Steel stud partition system. Studs @ 600cts max lined internally with 1 layer of 12mm Plywood. Internal grade. Sealed.
P2	INTERNAL - 92mm Steel stud partition system. Studs @ 600cts max to underside of slab or structure above, Line with 1 layer 13mm flush jointed Plasterboard both sides. Moisture resistant P/board to all wet areas with 92mm stud @ 450cts max. R1.5 Insulation Batts to all interna walls. Typ.
P3	INTERNAL - 92mm Steel stud partition system. Studs @ 600cts max to underside of slab or structure above. Line with 1 layer 13mm flush jointed Plasterboard to one side only. Moisture resistant P/board to all wet areas with 92mm stud @ 450cts max. R1.5 Insulation
P4	INTERNAL - 35mm Furring Channel @ 600cts max, lined with 1 layer of 13mm flush jointed plasterboard.
P5	Proprietary 2 Hour Fire Rated Plasterboard system - Line with 3 x13mm Fyrchek plasterboard. Full height to underside of floor slab above. Fire sealant to all junctions and abutting other surfaces. Install as per Manuf' system requirements.
W1	150mm Thick Precast Concrete Panel Wall. Class 2 - Trowel Finish. Painted.
W2	200mm Thick Precast Concrete Panel Wall. Class 2 - Trowel Finish. Painted.
W3	150mm Steel Stud Partition System. Stude at 600 cts max. External - Fix 35mm furring channels to studwork and line with 9mm Fibre Cement Sheet with expressed joints. Painted. Internal - Line with 12mm Plywood Internal Grade. Seal. Install Sarking behind FC sheet and R2.5 Insulation Batts to external walls.
W4	390x190x90mm Concrete Blockwork in a running bond pattern. 10mm Cement Render to match adjacent piers. Painted: PNT1 - Surfmist.
W5	EXTERNAL - Fix 35mm furring channels to fascia framing at 600 cts max. Line with 9mm Fibre Cement Sheet with expressed joints. Painted. REAR - Fix zincalume metal cladding (Fielders TL-5) to rear of fascia above roof level. Flash onto roofing.
W6	EXTERNAL - Fix 35mm furring channels to substrate framing at 600 cts max. Line with 9mm Fibre Cement Sheet with expressed joints. Painted. Sarking between channels and substrate framing.

T	Description .	
Tag . BAI - 1		
	Proprietary Glass Balustrade system, in accordance with AS1288. Posts at 2m cts max, welded to PFC.	
BG-01	600 W x 150mm Deep Box gutter folded from 0.8mm zincalume sheeting. Spandek gutter board on adjustable box gutter support straps at 900 cts max. 1 in 200 Fall to sumps.	
BG-02	300 W x 75mm Deep Box gutter folded from 0.8mm zincalume sheeting. 30x0.8mm Galv support straps at 900 cts max. 1 in 200 Fall to sumps.	
DP2-150Ø	150 Dia.PVC Downpipe. Connect to in-ground storwater system. Painted: Colorbond Surfmist	
DP-SPR	Downpipe Spreader onto lower roof. Same size as downpipe.	
DPM	Damp proof membrane	
EG1	Fieders "Urbis" Eaves Gutter. Colorbond Surfmist to match existing adjoining Building.	
FC	Fascia capping Colorbond Surfmist to match existing adjoining Building.	
FL	Flashing. Colorbond Surmist where visible. Zincalume where not visible.	
FL-1	Flashing Colorbond to match existing adjoining Building. Colour: Surfmist.	
GRATING-1	Selected Galv. floor grating system fixed to structural steel framing / joist with proprietary fixings.	
HR-5	Proprietry Galv.Handrail & Balustrade system. Handrail 1000mm above F.F.L. (Monowills or Moddex)	
LADD	Galv.Ladder to be designed and installed in accordance with AS1657.	
PC	Parapet wall capping Colorbond to match existing adjoining Building. Colour: Surfmist.	
RC	Ridge capping Zincalume to match Roofing.	
RFS-01	Fielders TL-5 Zincalume Metal roof cladding, to match existing adjoining Building.	
SOG1	New Concrete Slab / Footing on ground, as per Struct.Eng.Design.	
SS-1	New Suspended Concrete Slab, as per Struct.Eng.Design.	
SS-3	New Suspended Concrete Slab, as per Struct.Eng.Design.	
ST-BM	Structural Steel Framing (Beam / Rafter / Window Head), as per Struct.Eng.Design.	
TGSI	Tactile Ground Surface Indicator of 30% contrasting colour, in accordance with AS1428.	
TMB-SP_FL OOR	Proprietary timber sprung sports flooring system, as per Flooring Contractors design. Allow 100mm setdown to concrete floor slab.	
WALK_BD	Proprietary Walkboard system, fixed to roofing in accordance with Manuf' details.	

3	Issued for Building Rules Consent	30/06/22
2	Updated Plans	28/06/22
1	Updated Plans	06/06/22
Issue	Amendments	Date
Proje	ct	
BC	CC Stage 6 - Gym + GLA	λ
141	Boucaut Avenue, Blakev	iew. S.A.

Drawing SECTION SHEET 2

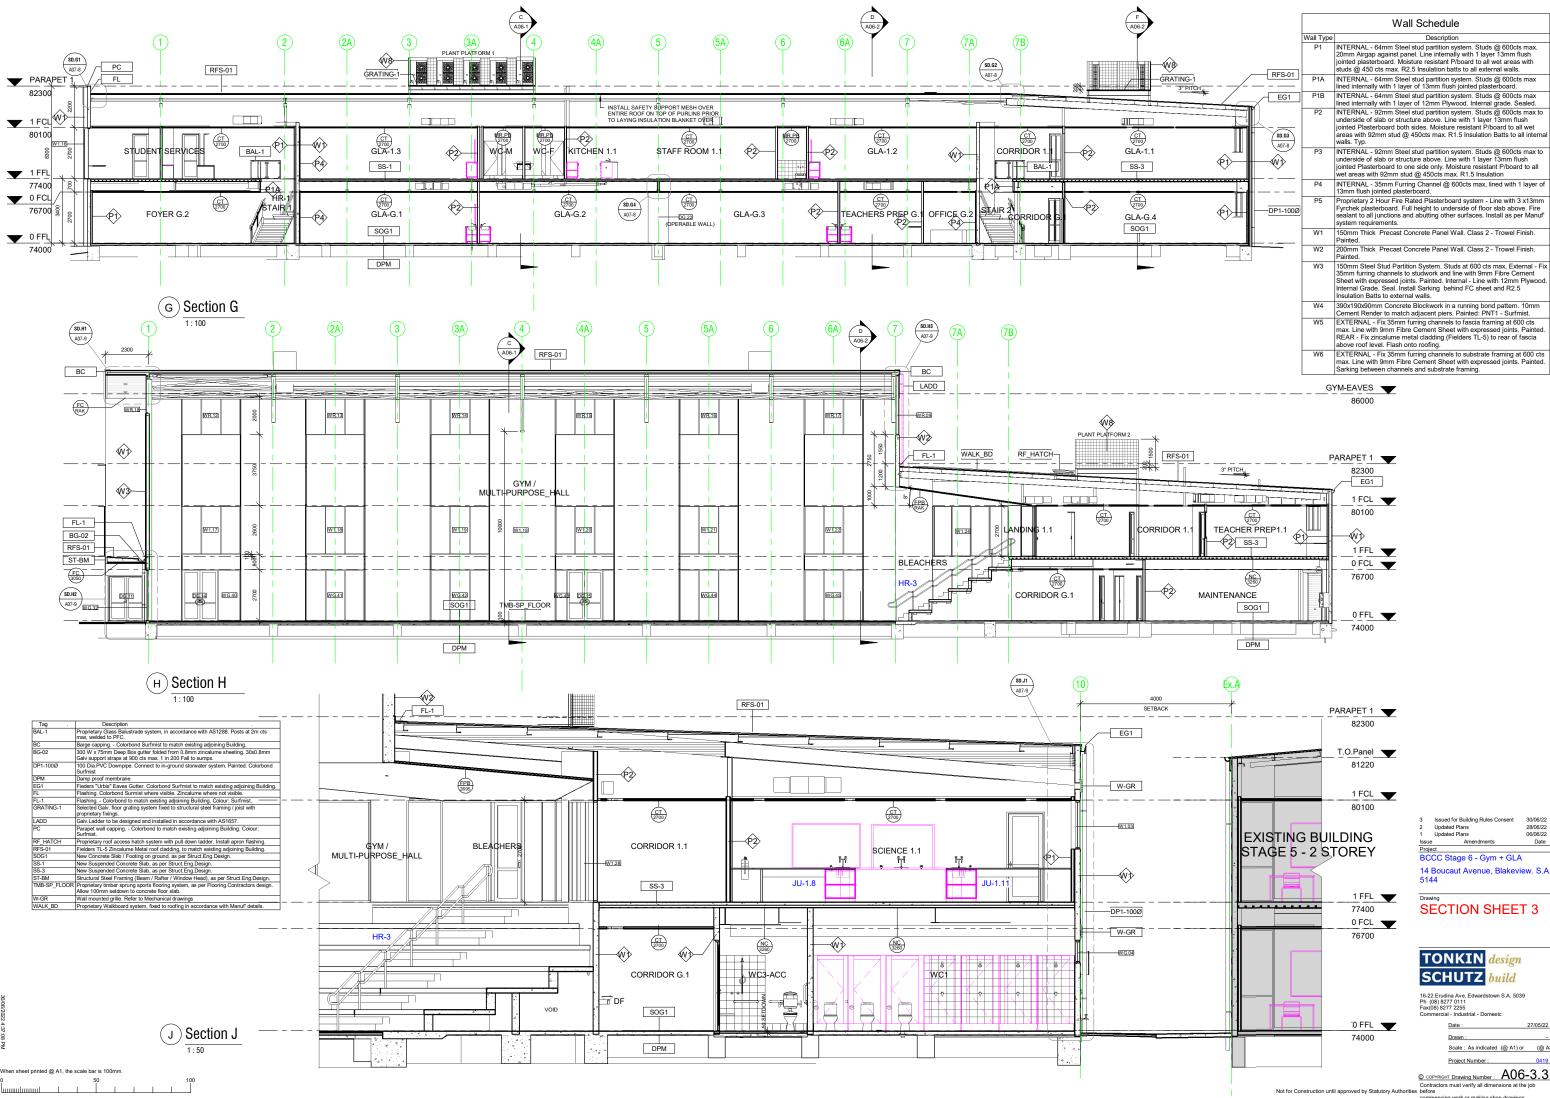


16-22 Erudina Ave, Edwardstown S.A. 5039 Ph (08) 8277 0111 Fax(08) 8277 2255 Commercial - Industrial - Domestc Date : 27/05/22

Scale : As indicated (@ A1) or	(@ A
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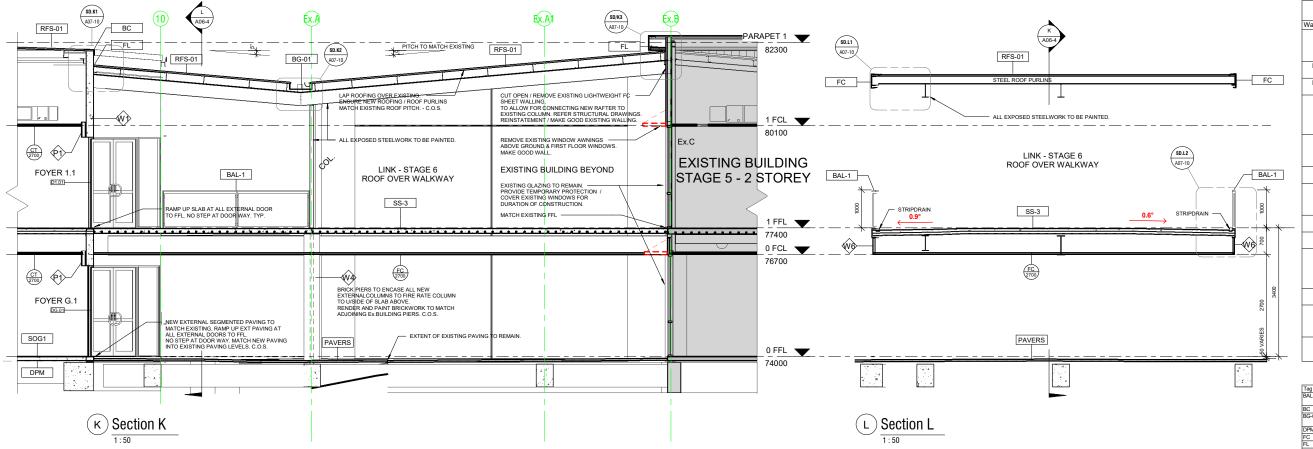
Contractors must verify all dimensions at the jo s before commencing work or making shop drawings.



3	Issued for Building Rules Consent	30/06/22
2	Updated Plans	28/06/22
1	Updated Plans	06/06/22
Issue	Amendments	Date
Proje	ct	
BC	CC Stage 6 - Gym + GLA	A
14	Boucaut Avenue, Blakev	iew. S.A.
51/	1	

16-22 Erudina Ave, Edwardstown S.A. Ph (08) 8277 0111 Fax(08) 8277 2255 Commercial - Industrial - Domestc	5039
Date :	27/05/22
Drawn :	
Scale : As indicated (@ A	(@ A3)
Project Number :	0419
COPYRIGHT Drawing Number : A	06-3.3

ncing work or making shop drawing



Wall Schedule	
Wall Type	Description
P1	INTERNAL - 64mm Steel stud partition system. Studs @ 600cts max. 20mm Airgap against panel. Line internally with 1 layer 13mm flush jointed plasterboard. Moisture resistant P/board to all wet areas with studs @ 450 cts max. R2.5 Insulation batts to all external walls.
P1A	INTERNAL - 64mm Steel stud partition system. Studs @ 600cts max lined internally with 1 layer of 13mm flush jointed plasterboard.
P1B	INTERNAL - 64mm Steel stud partition system. Studs @ 600cts max lined internally with 1 layer of 12mm Plywood. Internal grade. Sealed.
P2	INTERNAL - 92mm Steel stud partition system. Studs @ 600cts max to underside of alab or structure above. Line with 1 layer 13mm flush jointed Plasterboard both sides, Moisture resistant P/board to all wet areas with 92mm stud @ 450cts max. R1.5 Insulation Batts to all internal walls. Typ.
P3	INTERNAL - 92mm Steel stud partition system. Studs @ 600cts max to underside of slab or structure above. Line with 1 layer 13mm flush jointed Plasterboard to one side only. Moisture resistant P/board to all wet areas with 92mm stud @ 450cts max. R1.5 Insulation
P4	INTERNAL - 35mm Furring Channel @ 600cts max, lined with 1 layer of 13mm flush jointed plasterboard.
P5	Proprietary 2 Hour Fire Rated Plasterboard system - Line with 3 x13mm Fyrchek plasterboard. Full height to underside of floor slab above. Fire sealant to all junctions and abutting other surfaces. Install as per Manuf system requirements.
W1	150mm Thick Precast Concrete Panel Wall. Class 2 - Trowel Finish. Painted.
W2	200mm Thick Precast Concrete Panel Wall. Class 2 - Trowel Finish. Painted.
W3	150nm Steel Stud Partition System, Studs at 600 cts max, External - Fix 36nm furring channels to studwork and line with 9nm Fibre Cement Sheet with expressed joints. Painted. Internal - Line with 12nm Plywood. Internal Grade. Seal. Install Sarking behind FC sheet and R2.5 Insulation Batts to external walls.
W4	390x190x90mm Concrete Blockwork in a running bond pattern. 10mm Cement Render to match adjacent piers. Painted: PNT1 - Surfmist.
W5	EXTERNAL - Fix 35mm furring channels to fascia framing at 600 cts max. Line with 9mm Fibre Cement Sheet with expressed joints. Painted. REAR - Fix zincalume metal cladding (Fielders TL-5) to rear of fascia above roof level. Flash onto roofing.
W6	EXTERNAL - Fix 35mm furring channels to substrate framing at 600 cts max. Line with 9mm Fibre Cement Sheet with expressed joints. Painted. Sarking between channels and substrate framing.

Tag	. Description .	
BAL-1	Proprietary Glass Balustrade system, in accordance with AS1288. Posts at 2m cts max, welded to PFC.	
BC	C Barge capping Colorbond Surfmist to match existing adjoining Building.	
BG-01	3G-01 600 W x 150mm Deep Box gutter folded from 0.8mm zincalume sheeting. Spandek gutter board on adjustable box gutter support straps at 900 cts max. 1 in 200 Fall to sumps.	
DPM	Damp proof membrane	
FC	Fascia capping Colorbond Surfmist to match existing adjoining Building.	
FL	Flashing. Colorbond Surmist where visible. Zincalume where not visible.	
PAVERS	Selected segmented pavers on sand sub-base, to match existing pavers. Fall away from building.	
RFS-01	Fielders TL-5 Zincalume Metal roof cladding, to match existing adjoining Building.	
SOG1	New Concrete Slab / Footing on ground, as per Struct.Eng.Design.	
SS-3	New Suspended Concrete Slab, as per Struct.Eng.Design.	


3 2 1	Issued for Building Rules Consent Updated Plans Updated Plans	30/06/22 28/06/22 06/06/22	
Issu		Date	
14	Project BCCC Stage 6 - Gym + GLA 14 Boucaut Avenue, Blakeview. S.A. 5144		
	SECTION SHEET 4		



16-22 Erudina Ave, Edwardstown S.A. 5039 Ph (08) 8277 0111 Fax(08) 8277 2255 Commercial - Industrial - Domesto Date : 27/05/22 Drawn : -Scale : 1 : 50 (@ A1) or (@ A3) Project Number : 0419

© COPVRIGHT Drawing Number : A06-4.3 Contractors must verify all dimensions at the job se before commencing work or making shop drawings.

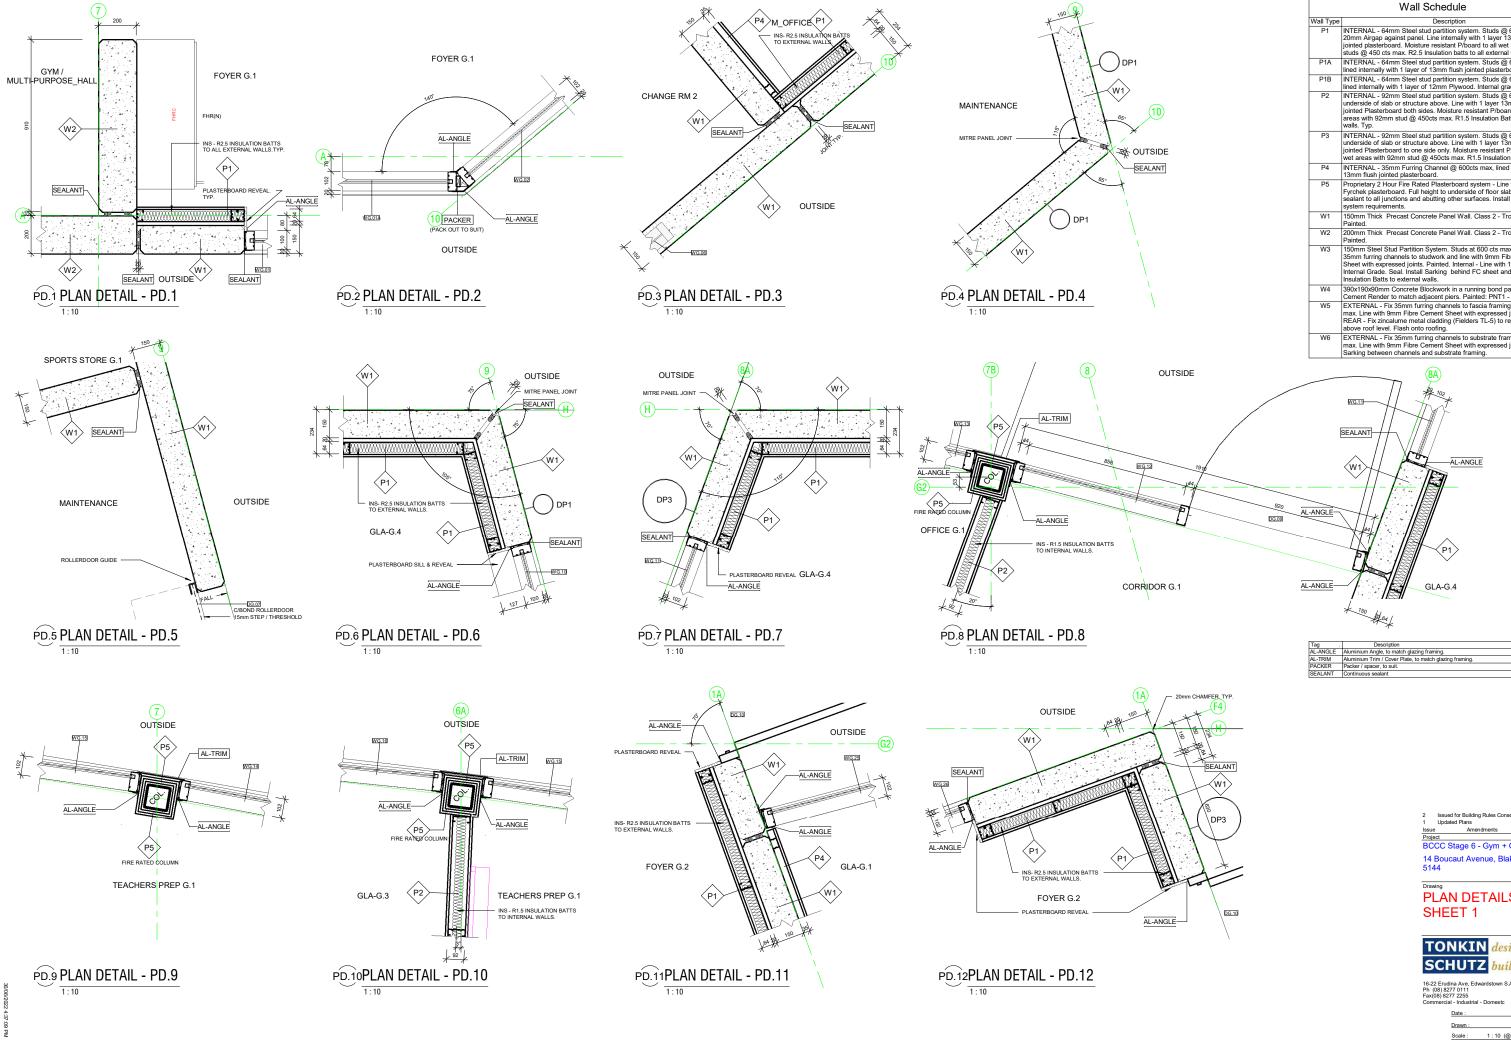Not for Construction until approved by Statutory Authorities before



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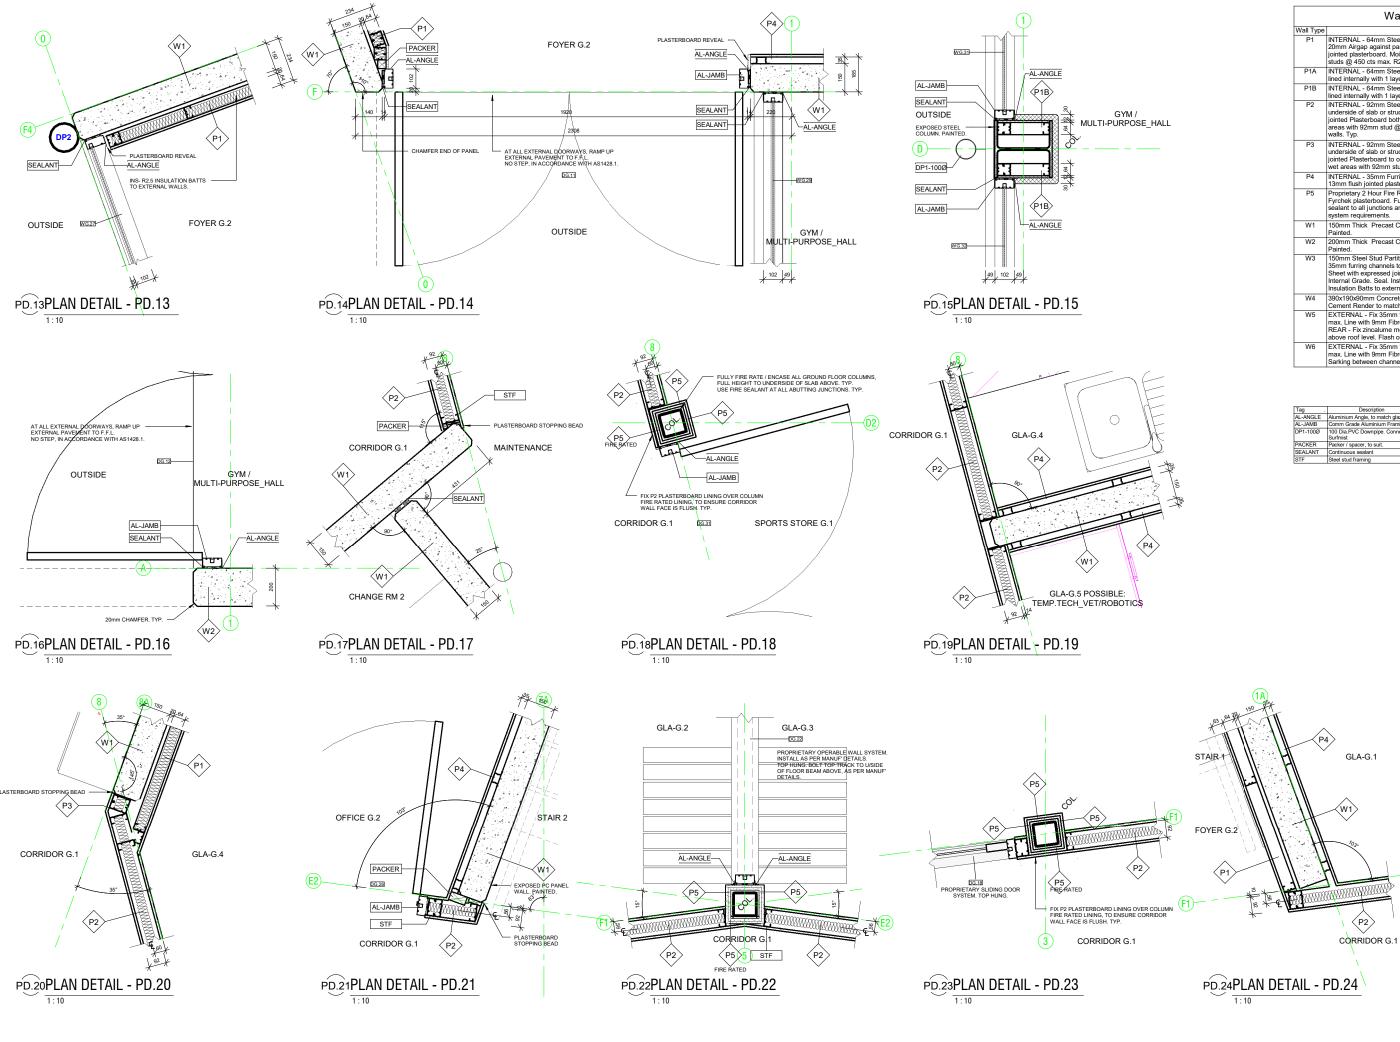
When sheet printed @ A1. the scale bar is 100mm.

	Wall Schedule		
Wall Type	Description		
P1	INTERNAL - 64mm Steel stud partition system. Studs @ 600cts max. 20mm Airgap against panel. Line internally with 1 layer 13mm flush jointed plasterboard. Moisture resistant Pboard to all wet areas with studs @ 450 cts max. R2.5 Insulation batts to all external walls.		
P1A	INTERNAL - 64mm Steel stud partition system. Studs @ 600cts max lined internally with 1 layer of 13mm flush jointed plasterboard.		
P1B	INTERNAL - 64mm Steel stud partition system. Studs @ 600cts max lined internally with 1 layer of 12mm Plywood. Internal grade. Sealed.		
P2	INTERNAL - 92mm Steel stud partition system. Studs @ 600cts max to underside of slab or structure above. Line with 1 layer 13mm flush jointed Plasterboard both sides. Moisture resistant P/board to all wet areas with 92mm stud @ 450cts max. R1.5 Insulation Batts to all internal walls. Typ.		
P3	INTERNAL - 92mm Steel stud partition system. Studs @ 600cts max to underside of slab or structure above. Line with 1 layer 13mm flush jointed Plasterboard to one side only. Moisture resistant P/board to all wet areas with 92mm stud @ 450cts max. R1.5 Insulation		
P4	INTERNAL - 35mm Furring Channel @ 600cts max, lined with 1 layer of 13mm flush jointed plasterboard.		
P5	Proprietary 2 Hour Fire Rated Plasterboard system - Line with 3 x13mm Fyrchek plasterboard. Full height to underside of floor slab above. Fire sealant to all junctions and abutting other surfaces. Install as per Manuf system requirements.		
W1	150mm Thick Precast Concrete Panel Wall. Class 2 - Trowel Finish. Painted.		
W2	200mm Thick Precast Concrete Panel Wall. Class 2 - Trowel Finish. Painted.		
W3	150nm Steel Stud Partition System. Studs at 600 cts max. External - Fix 36mm furring channels to studwork and line with 9mm Fibre Cement Sheet with expressed joints. Painted. Internal - Line with 12mm Plywood. Internal Grade. Seal. Install Sarking behind FC sheet and R2.5 Insulation Batts to external walls.		
W4	390x190x90mm Concrete Blockwork in a running bond pattern. 10mm Cement Render to match adjacent piers. Painted: PNT1 - Surfmist.		
W5	EXTERNAL - Fix 35mm furring channels to fascia framing at 600 cts max. Line with 9mm Fibre Cement Sheet with expressed joints. Painted. REAR - Fix zincalume metal cladding (Fielders TL-5) to rear of fascia above roof level. Flash onto roofing.		
W6	EXTERNAL - Fix 35mm furring channels to substrate framing at 600 cts max. Line with 9mm Fibre Cement Sheet with expressed joints. Painted.		

Tag .	Description .
AL-ANGLE	Aluminium Angle, to match glazing framing.
AL-TRIM	Aluminium Trim / Cover Plate, to match glazing framing.
PACKER	Packer / spacer, to suit.
SEALANT	Continuous sealant

2 Issued for Building Rules Consent	30/06/22
1 Updated Plans	28/06/22
Issue Amendments	Date
Project	
BCCC Stage 6 - Gym + GLA	λ
14 Boucaut Avenue, Blakev 5144	iew. S.A.
Drawing	
PLAN DETAILS -	•
SHEET 1	
ONEET	
TONKIN design	l.
SCHUTZ build	
16-22 Erudina Ave, Edwardstown S.A. 503 Ph (08) 8277 0111 Fax(08) 8277 2255 Commercial - Industrial - Domestc	39
Date :	16/06/22
Drawn :	<u> </u>
Scale : 1 : 10 (@ A1)	or (@ A3)
Project Number :	0419
© COPYRIGHT Drawing Number : A0	

Contractors must verify all dimensions at the before ncing work or making shop drawings



When sheet printed @ A1, the scale bar is 100mm.

	Wall Schedule	
Wall Type	Description	
P1	INTERNAL - 64mm Steel stud partition system. Studs @ 600cts max. 20mm Airgap against panel. Line internally with 1 layer 13mm flush jointed plasterboard. Moisture resistant P/board to all wet areas with studs @ 450 cts max. R2.5 Insulation batts to all external walls.	
P1A	INTERNAL - 64mm Steel stud partition system. Studs @ 600cts max lined internally with 1 layer of 13mm flush jointed plasterboard.	
P1B	INTERNAL - 64mm Steel stud partition system. Studs @ 600cts max lined internally with 1 layer of 12mm Plywood. Internal grade. Sealed.	
P2	INTERNAL - 92mm Steel stud partition system. Studs @ 600cts max to underside of slab or structure above. Line with 1 layer 13mm flush jointed Plasterboard both sides, Moisture resistant P/board to all wet areas with 92mm stud @ 450cts max. R1.5 Insulation Batts to all internal walls. Typ.	
P3	INTERNAL - 92mm Steel stud partition system. Studs @ 600cts max to underside of slab or structure above. Line with 1 layer 13mm flush jointed Plasterboard to one side only. Moisture resistant P/board to all wet areas with 92mm stud @ 450cts max. R1.5 Insulation	
P4	INTERNAL - 35mm Furring Channel @ 600cts max, lined with 1 layer of 13mm flush jointed plasterboard.	
P5	Proprietary 2 Hour Fire Rated Plasterboard system - Line with 3 x13mm Fyrchek plasterboard. Full height to underside of floor slab above. Fire sealant to all junctions and abutting other surfaces. Install as per Manuf system requirements.	
W1	150mm Thick Precast Concrete Panel Wall. Class 2 - Trowel Finish. Painted.	
W2	200mm Thick Precast Concrete Panel Wall. Class 2 - Trowel Finish. Painted.	
W3	150nm Steel Stud Partition System. Studs at 600 cts max. External - Fix 36mm furing channels to studwork and line with 9mm Fibre Cement Sheet with expressed joints. Painted. Internal - Line with 12mm Plywood. Internal Grade. Seal. Install Sarking behind FC sheet and R2.5 Insulation Batts to external walls.	
W4	390x190x90mm Concrete Blockwork in a running bond pattern. 10mm Cement Render to match adjacent piers. Painted: PNT1 - Surfmist.	
W5	EXTERNAL - Fix 35mm furring channels to fascia framing at 600 cts max. Line with 9mm Fibre Cement Sheet with expressed joints. Painted. REAR - Fix zincalume metal cladding (Fielders TL-5) to rear of fascia above roof level. Flash onto roofing.	
W6	EXTERNAL - Fix 35mm furring channels to substrate framing at 600 cts max. Line with 9mm Fibre Cement Sheet with expressed joints. Painted. Sarking between channels and substrate framing.	

Tag .	Description .
AL-ANGLE Aluminium Angle, to match glazing framing.	
AL-JAMB	Comm Grade Aluminium Framing - Jamb / Mullion.
DP1-100Ø	100 Dia.PVC Downpipe. Connect to in-ground storwater system. Painted: Colorbond Surfmist
PACKER	Packer / spacer, to suit.
SEALANT	Continuous sealant
STF	Steel stud framing

2	Issued for Building Rules Consent	30/06/22
1	Updated Plans	28/06/22
Issue	Amendments	Date
Proje	ct	
BC	CC Stage 6 - Gym + GL/	Α
14 I	Boucaut Avenue, Blakev	iew. S.A.
514	4	
Draw	ing	

PLAN DETAILS -SHEET 2



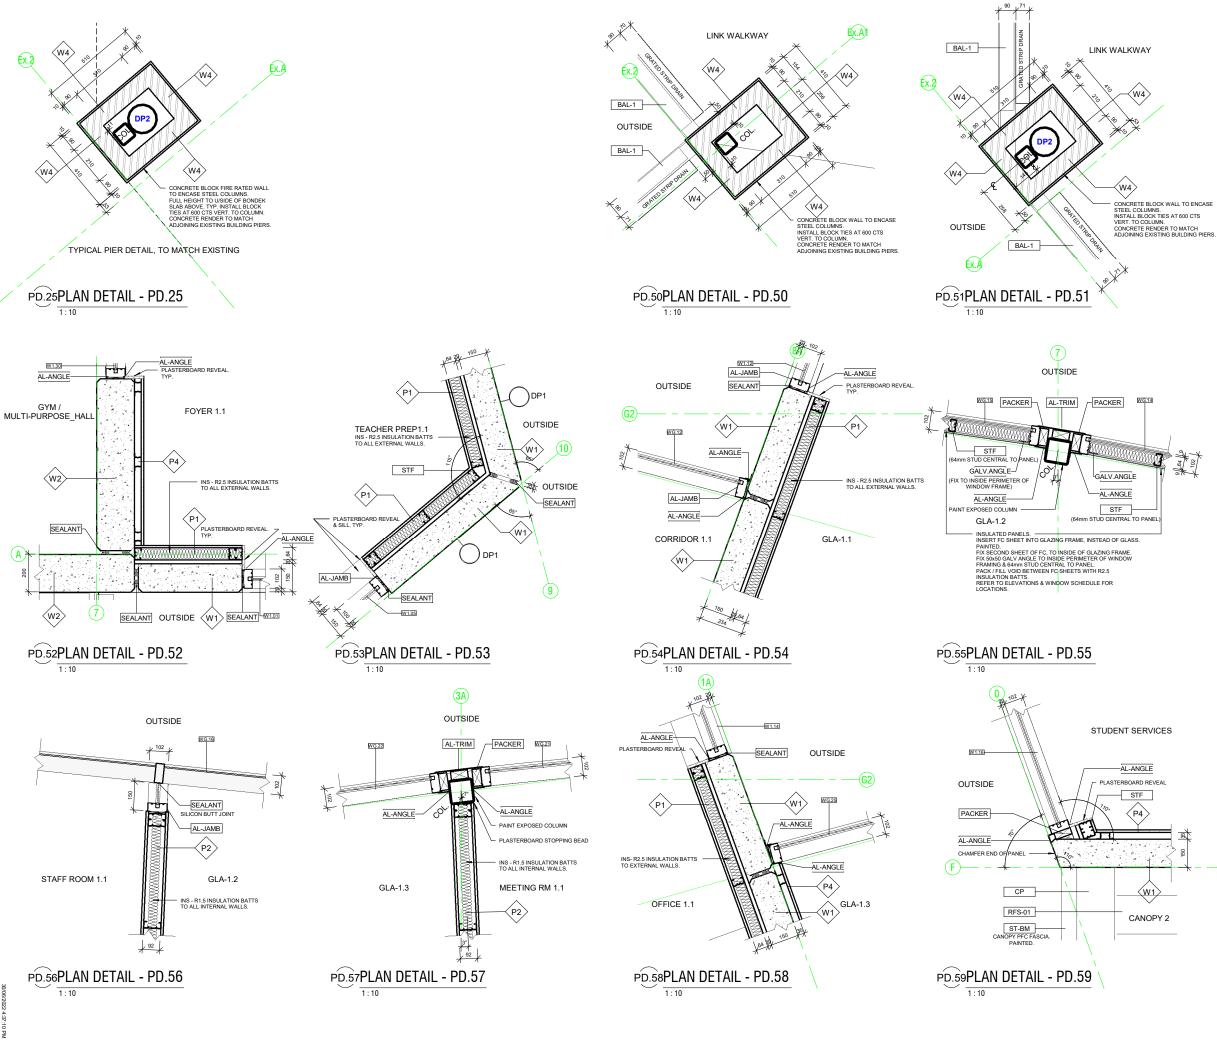
16-22 Erudina Ave, Edwardstown S.A. 5039 Ph (08) 8277 0111 Eav(08) 8277 2255 1:10 (@ A1) or (@ A3) Scale :

0419

© COPYRIGHT Drawing Number : A07-2.2 Contractors must verify all dimen before

Project Number

ncing work or making shop drawings



When sheet printed @ A1, the scale bar is 100mm

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Wall Schedule		
Wall Type	Description	
P1	INTERNAL - 64mm Steel stud partition system. Studs @ 600cts max. 20mm Airgap against panel. Line internally with 1 layer 13mm flush jointed plasterboard. Moisture resistant Plobard to all wet areas with studs @ 450 cts max. R2.5 Insulation batts to all external walls.	
P1A	INTERNAL - 64mm Steel stud partition system. Studs @ 600cts max lined internally with 1 layer of 13mm flush jointed plasterboard.	
P1B	INTERNAL - 64mm Steel stud partition system. Studs @ 600cts max lined internally with 1 layer of 12mm Plywood. Internal grade. Sealed.	
P2	INTERNAL - 92mm Steel stud partition system. Studs @ 600cts max to underside of slab or structure above. Line with 1 layer 13mm flush jointed Plasterboard both sides. Moisture resistant P/board to all wet areas with 92mm stud @ 450cts max. R1.5 Insulation Batts to all internal walls. Typ.	
P3	INTERNAL - 92mm Steel stud partition system. Studs @ 600cts max to underside of slab or structure above. Line with 1 layer 13mm flush jointed Plasterboard to one side only. Moisture resistant P/board to all wet areas with 92mm stud @ 450cts max. R1.5 Insulation	
P4	INTERNAL - 35mm Furring Channel @ 600cts max, lined with 1 layer of 13mm flush jointed plasterboard.	
P5	Proprietary 2 Hour Fire Rated Plasterboard system - Line with 3 x13mm Fyrchek plasterboard. Full height to underside of floor slab above. Fire sealant to all junctions and abutting other surfaces. Install as per Manuf system requirements.	
W1	150mm Thick Precast Concrete Panel Wall. Class 2 - Trowel Finish. Painted.	
W2	200mm Thick Precast Concrete Panel Wall. Class 2 - Trowel Finish. Painted.	
W3	150nm Steel Stud Partition System. Studs at 600 cts max. External - Fix 36mm furing channels to studwork and line with 9mm Fibre Cement Sheet with expressed joints. Painted. Internal - Line with 12mm Plywood. Internal Grade. Seal. Install Sarking behind FC sheet and R2.5 Insulation Batts to external walls.	
W4	390x190x90mm Concrete Blockwork in a running bond pattern. 10mm Cement Render to match adjacent piers. Painted: PNT1 - Surfmist.	
W5	EXTERNAL - Fix 35mm furring channels to fascia framing at 600 cts max. Line with 9mm Fibre Cement Sheet with expressed joints. Painted. REAR - Fix zincalume metal cladding (Fielders TL-5) to rear of fascia above roof level. Flash onto roofing.	
W6	EXTERNAL - Fix 35mm furring channels to substrate framing at 600 cts max. Line with 9mm Fibre Cement Sheet with expressed joints. Painted. Sarking between channels and substrate framing.	

 Tag
 Description

 AL_ANGLE
 Aluminum Angle, to match glazing framing.

 AL_ANMB
 Comm Grade Aluminium Framing - Jamb / Mullion.

 AL_TRIM
 Aluminium Tirm in / Cover Plate, to match glazing framing.

 BAL-1
 Proprietary Class Balustrade system, in accordance with AS1288. Posts at 2m cts max welded to PFC.
 apping. - Colorbond to match existing adjoining Building. Colour: Surfmist 0x50x1.2mm Folded Galvanised Angle Packer / spacer, to suit ielders TL-5 Zincalum ST-BM Structural Steel Framing (Beam / Rafter / Window Head), as per Struct Steel stud framing

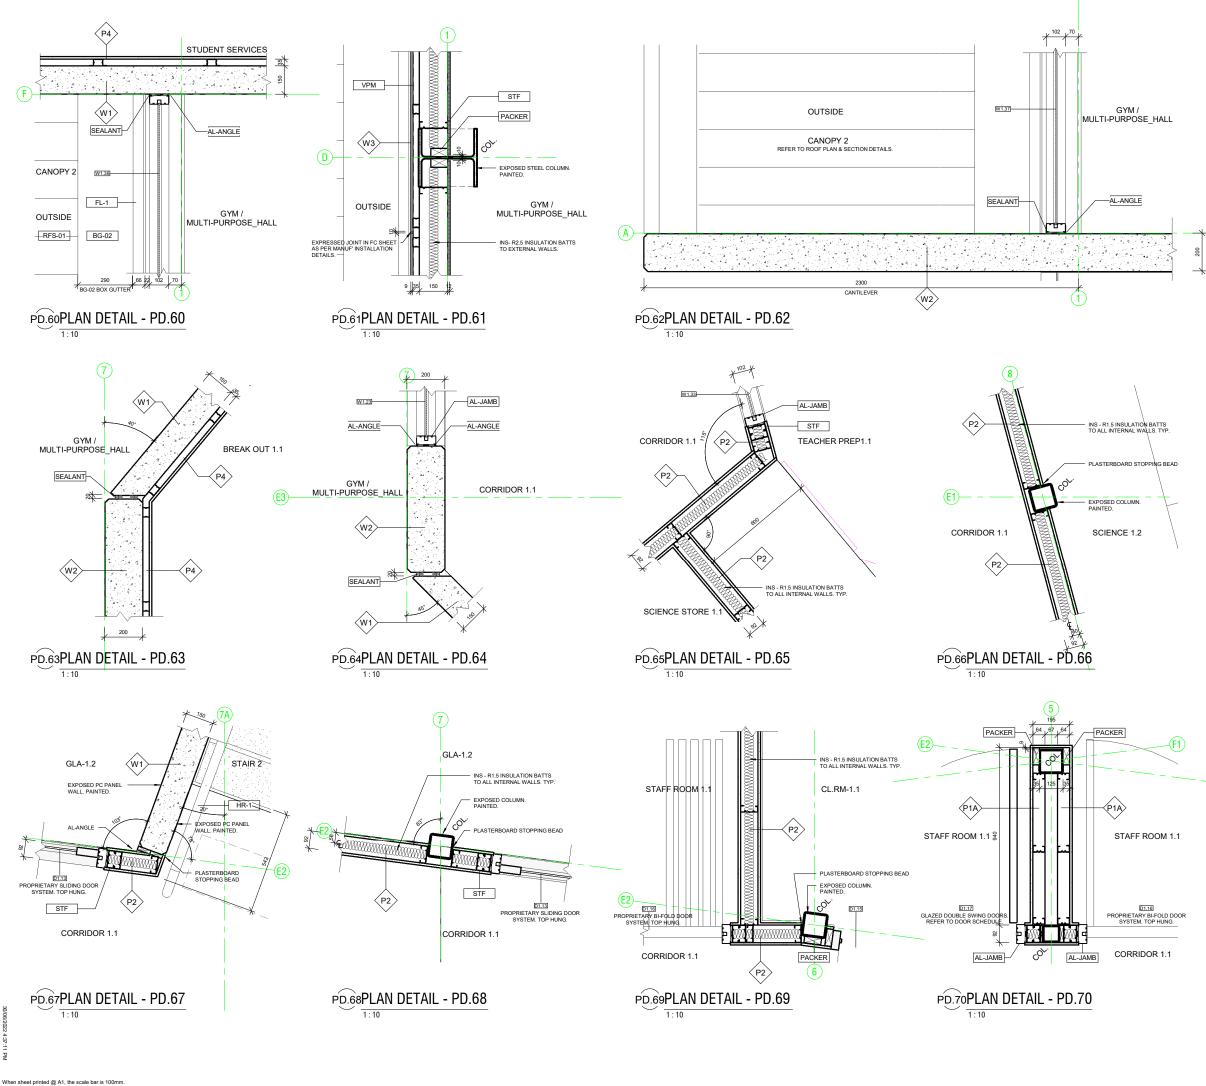




16-22 Erudina Ave, Edwardstown S.A. 5039 Ph (08) 8277 0111 Fax(08) 8277 2255 Commercial - Industrial - Domestc Date : 16/06/22 Drawn Scale : 1 : 10 (@ A1) or (@ A3)

Project Number : 0419 © COPYRIGHT Drawing Number : A07-3.2

Contractors must verify all dimensions at the just before commencing work or making shop drawings. Not for Construction until approved by Statutory Au



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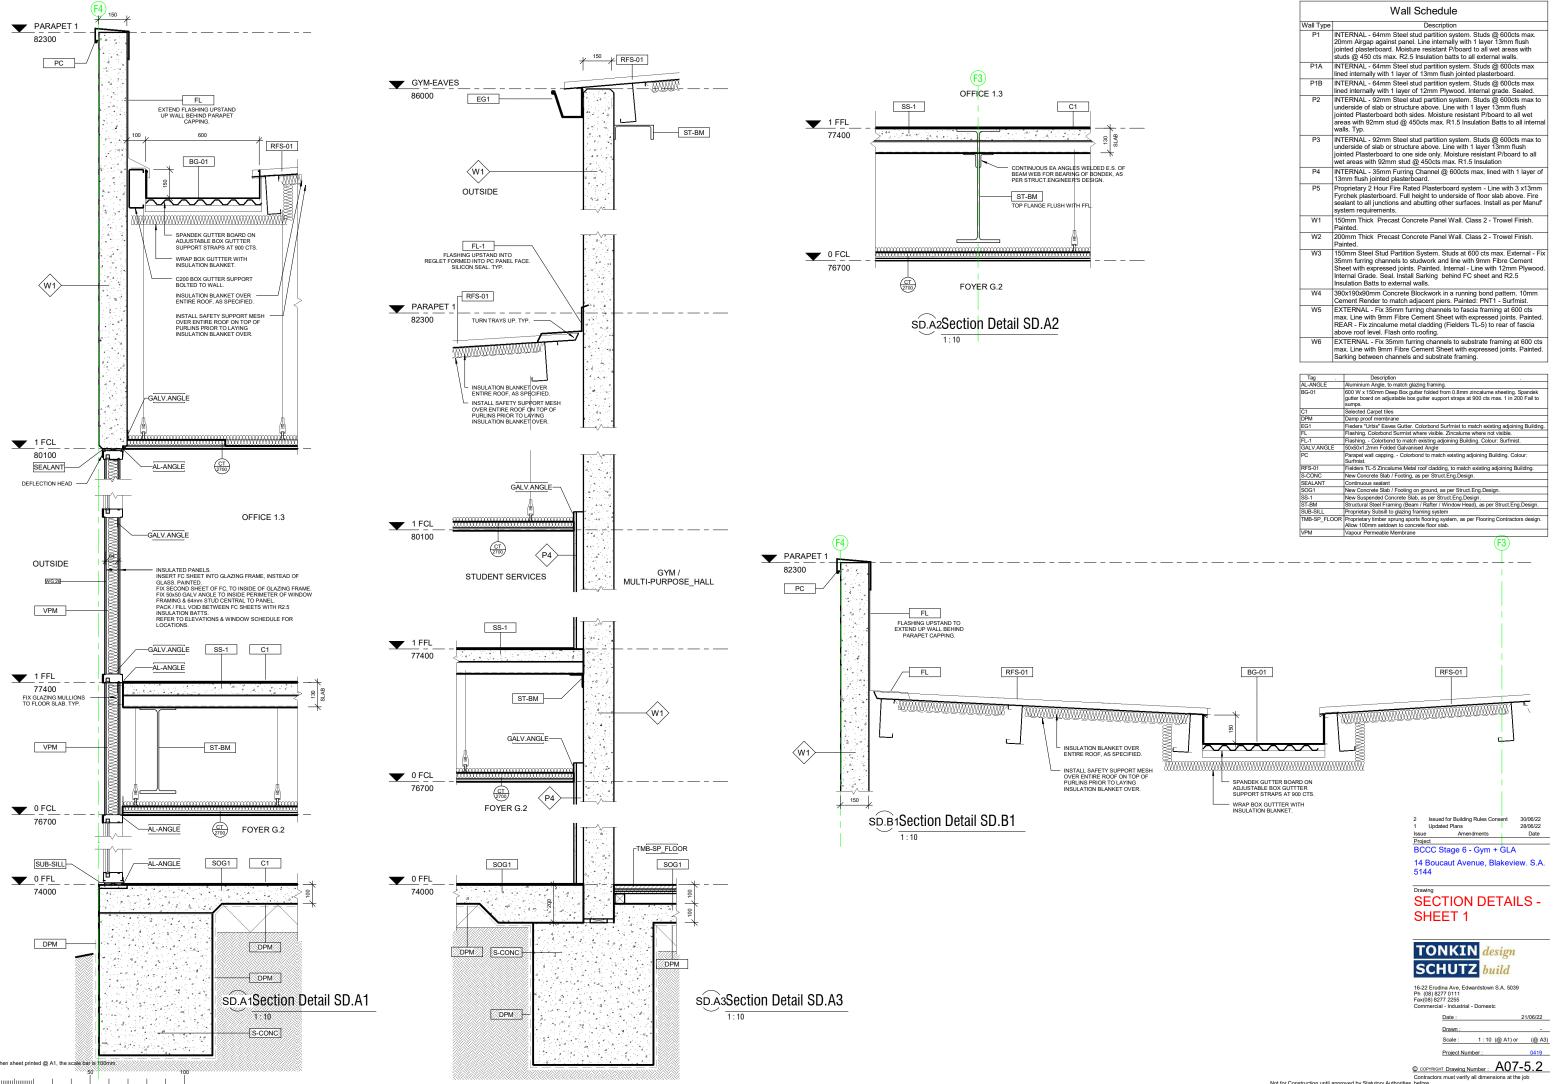
	Wall Schedule		
Wall Type	Description		
P1	INTERNAL - 64mm Steel stud partition system. Studs @ 600cts max. 20mm Airgap against panel. Line internally with 1 layer 13mm flush jointed plasterboard. Moisture resistant P/board to all wet areas with studs @ 450 cts max. R2.5 Insulation batts to all external walls.		
P1A	INTERNAL - 64mm Steel stud partition system. Studs @ 600cts max lined internally with 1 layer of 13mm flush jointed plasterboard.		
P1B	INTERNAL - 64mm Steel stud partition system. Studs @ 600cts max lined internally with 1 layer of 12mm Plywood. Internal grade. Sealed.		
P2	INTERNAL - 92mm Steel stud partition system. Studs @ 600cts max to underside of slab or structure above. Line with 1 layer 13mm flush jointed Plasterboard both sides, Moisture resistant P/board to all wet areas with 92mm stud @ 450cts max. R1.5 Insulation Batts to all internal walls. Typ.		
P3	INTERNAL - 92mm Steel stud partition system. Studs @ 600cts max to underside of slab or structure above. Line with 1 layer 13mm flush jointed Plasterboard to one side only. Moisture resistant P/board to all wet areas with 92mm stud @ 450cts max. R1.5 Insulation		
P4	INTERNAL - 35mm Furring Channel @ 600cts max, lined with 1 layer of 13mm flush jointed plasterboard.		
P5	Proprietary 2 Hour Fire Rated Plasterboard system - Line with 3 x13mm Fyrchek plasterboard. Full height to underside of floor slab above. Fire sealant to all junctions and abutting other surfaces. Install as per Manuf system requirements.		
W1	150mm Thick Precast Concrete Panel Wall. Class 2 - Trowel Finish. Painted.		
W2	200mm Thick Precast Concrete Panel Wall. Class 2 - Trowel Finish. Painted.		
W3	150nm Steel Stud Partition System. Studs at 600 cts max. External - Fix 36mm furring channels to studwork and line with 9mm Fibre Cement Sheet with expressed joints. Painted. Internal - Line with 12mm Plywood. Internal Grade. Seal. Install Sarking behind FC sheet and R2.5 Insulation Batts to external walls.		
W4	390x190x90mm Concrete Blockwork in a running bond pattern. 10mm Cement Render to match adjacent piers. Painted: PNT1 - Surfmist.		
W5	EXTERNAL - Fix 35mm furring channels to fascia framing at 600 cts max. Line with 9mm Fibre Cement Sheet with expressed joints. Painted. REAR - Fix zincalume metal cladding (Fielders TL-5) to rear of fascia above roof level. Flash onto roofing.		
W6	EXTERNAL - Fix 35mm furring channels to substrate framing at 600 cts max. Line with 9mm Fibre Cement Sheet with expressed joints. Painted. Sarking between channels and substrate framing.		

Tag .	Description .	
AL-ANGLE	Aluminium Angle, to match glazing framing.	
AL-JAMB		
BG-02		
FL-1	Flashing Colorbond to match existing adjoining Building. Colour: Surfmist.	
HR-1	48 Dia. Stainless Steel handrail fixed to wall with proprietary handrail brackets.Handrail 1000 above F.F.L. with second handrail at 750mm above FFL / stair nosing.	
PACKER	Packer / spacer, to suit.	
RFS-01	Fielders TL-5 Zincalume Metal roof cladding, to match existing adjoining Building.	
SEALANT	VT Continuous sealant Steel stud framing	
STF		
VPM	Vapour Permeable Membrane	



Contractors must verify all dimensions at the jo before


ction until approved by Statutor ncing work or making shop drawings



walls. Typ. P3 INTERNAL - 92mm Siteel stud partition system. Studs @ 600cts max to underside of slab or structure above. Line with 1 layer 13mm flush jointed Plasterboard to one side only. Moisture resistant P/board to all wet areas with 92mm stud @ 450cts max. R1.5 Insulation P4 INTERNAL - 35mm Furring Channel @ 600cts max, lined with 1 layer of 13mm flush jointed plasterboard. P5 Proprietary 2 Hour Fire Rated Plasterboard system - Line with 3 x13mm Fyrchek plasterboard. Full height to underside offor slab above. Fire sealant to all junctions and abuting other surfaces. Install as per Manuff system requirements. W1 150mm Thick Precast Concrete Panel Wall. Class 2 - Trowel Finish. Painted. W2 200mm Thick Precast Concrete Panel Wall. Class 2 - Trowel Finish. Painted. W3 150mm Steel Stud Partition System. Studs at 600 cts max. External - Fix 30mm furring channels to studwork and line with 9mm Fibre Cement	Wall Schedule			
 20mm Airgap against panel. Line internally with 1 layer 13mm flush jointed plasterboard. Moisture resistant P/board to all wet areas with studs @ 400 cts max. R2.5 Insulation batts to all external walls. P1A INTERNAL - 64mm Steel stud partition system. Studs @ 600cts max lined internally with 1 layer of 13mm flush jointed plasterboard. P1B INTERNAL - 64mm Steel stud partition system. Studs @ 600cts max lined internally with 1 layer of 13mm flush jointed plasterboard. P2 INTERNAL - 64mm Steel stud partition system. Studs @ 600cts max lined internally with 1 layer of 12mm Plywood. Internal grade. Sealed. P2 INTERNAL - 92mm Steel stud partition system. Studs @ 600cts max to underside of slab or structure above. Line with 1 layer 13mm flush jointed Plasterboard both sides. Moisture resistant P/board to all wet areas with 92mm stud @ 450cts max. R1.5 Insulation Batts to all internal walls. Typ. P3 INTERNAL - 92mm Steel stud partition system. Studs @ 600cts max to underside of slab or structure above. Line with 1 layer 13mm flush jointed Plasterboard to one side only. Moisture resistant P/board to all wet areas with 92mm stud @ 450cts max. R1.5 Insulation P4 INTERNAL 30mm Furring Channel @ 600cts max, lined with 1 layer of 13mm flush jointed plasterboard. P5 Proprietary 2 Hour Fire Rated Plasterboard system - Line with 3 x13mm Fyrotek plasterboard. Full height to underside of floor siab above. Fire sealant to all junctions and abutting other surfaces. Install as per Manuf' system requirements. W1 10mm Thick Precast Concrete Panel Wall. Class 2 - Trowel Finish. Painted. W2 200mm Thick Precast Concrete Panel Wall. Class 2 - Trowel Finish. Painted. W3 300x190x90mm Concrete Blockwork in a running bond pattern. 10mm Cement Sheet with appressed joints. Painted. Internal - Line with 13mm Plybood. Internal Grade. Seal. Install sarking behind FC sheet and R2.5 Insulation Batts to exter	Wall Type	Description		
 Ined internally with 1 layer of 13mm flush jointed plasterboard. P1B INTERNAL - 64mm Steel stud partition system. Studs @ 600cts max lived internally with 1 layer of 12mm Plywood. Internal grade. Sealed. INTERNAL - 92mm Steel stud partition system. Studs @ 600cts max to underside of elabor structure above. Line with 1 layer 13mm flush jointed Plasterboard both sides. Moisture resistant Plboard to all wet areas with 92mm stud @ 450cts max R1.5 Insulation Batts to all Internal walls. Typ. INTERNAL - 92mm Steel stud partition system. Studs @ 600cts max to underside of elabor structure above. Line with 1 layer 13mm flush jointed Plasterboard to one side only. Moisture resistant Plboard to all wet areas with 92mm stud @ 450cts max. R1.5 Insulation Batts to all Internal wells. Typ. INTERNAL - 92mm Steel stud partition system. Studs @ 600cts max to underside of fabor structure above. Line with 1 layer 13mm flush jointed Plasterboard to one side only. Moisture resistant Plboard to all wet areas with 92mm stud @ 450cts max. R1.5 Insulation INTERNAL - 35mm Furring Channel @ 600cts max, lined with 1 layer 13mm flush jointed plasterboard. E00cts max, lined with 1 layer 13mm flush jointed plasterboard. E00cts max, lined with 3 x13mm Fyrchek plasterboard. Full height to underside of floor slab above. Fire sealant to all junctions and abutling other surfaces. Install as per Manuf system requirements. W1 150mm Thick Precast Concrete Panel Wall. Class 2 - Trowel Finish. Painted. W2 200mm Thick Precast Concrete Panel Wall. Class 2 - Trowel Finish. Painted. W3 3105nm Steel Stud Partition System. Studs at 600 cts max. External - Fix 33mm furring channels to studwork and line with 9mm Fibre Cement Sheet with expressed joints. Painted. Internal 1. Line with 13mm Plywood. Internal Grade. Seal. Install Sarking behind FC sheet and R2.5 Insulation Batts to external walls. W4 3304190x90mm Concrete Blockwork in		20mm Airgap against panel. Line internally with 1 layer 13mm flush jointed plasterboard. Moisture resistant P/board to all wet areas with studs @ 450 cts max. R2.5 Insulation batts to all external walls.		
lined internally with 1 layer of 12mm Plywood. Internal grade. Sealed. P2 INTERNAL - 92mm Steel stud partition system. Studs @ 600cts max to underside of slab or structure above. Line with 1 layer 13mm flush jointed Plasterboard both sides. Moisture resistant P/board to all wet areas with 92mm stud @ 450cts max. R1.5 Insulation Batts to all internal walls. Typ. P3 INTERNAL - 92mm Steel stud partition system. Studs @ 600cts max to underside of slab or structure above. Line with 1 layer 13mm flush jointed Plasterboard to one side only. Moisture resistant P/board to all wet areas with 92mm stud @ 450cts max. R1.5 Insulation P4 INTERNAL - 35mm Furring Channel @ 600cts max, lined with 1 layer of 13mm flush jointed plasterboard. S40cts max. R1.5 Insulation P4 INTERNAL - 35mm Furring Channel @ 600cts max, lined with 1 layer of 13mm flush jointed plasterboard. Full height to underside of floor slab above. Fire sealant to all junctions and abutting other surfaces. Install as per Manuf system requirements. W1 160mm Thick Precast Concrete Panel Wall. Class 2 - Trowel Finish. Painted. W2 200mm Thick Precast Concrete Panel Wall. Class 2 - Trowel Finish. Painted. W3 150mm Steel Stud Partition System. Studs at 600 cts max. External - Fix 33mm furring channels to studowrk and line with 9mm Fibre Cement Sheet with expressed joints. Painted. Internal Line with 12mm Plywood. Internal Grade. Seal. Install Sarking behind FC sheet and R2.5 Insulation Batts to external walls. W4 390x190x90mm Concrete Blockwork in a running bond pattem. 10mm Cement Render to match adjacent piers. Painted. R2.6 In	P1A	lined internally with 1 layer of 13mm flush jointed plasterboard.		
 underside of slab or structure above. Line with 1 layer 13mm flush jointed Plasterboard both sides. Moisture resistant Phoard to all wet areas with 92mm stud @ 450cts max. R1.5 Insulation Batts to all internal walls. Typ. P3 IINTERNAL - 92mm Steel stud partition system. Studs @ 600cts max to underside of slab or structure above. Line with 1 layer 13mm flush jointed Plasterboard to one side only. Moisture resistant Phoard to all wet areas with 92mm stud @ 450cts max. R1.5 Insulation P4 INTERNAL - 35mm Furring Channel @ 600cts max, fl.s Insulation P4 INTERNAL - 35mm Furring Channel @ 600cts max, lined with 1 layer of 13mm flush jointed plasterboard. P5 Proprietary 2 Hour Fire Rated Plasterboard system - Line with 3 x13mm Fyr/chek plasterboard. Full height to underside of floor slab above. Fire sealant to all junctions and abutting other surfaces. Install as per Manuf system requirements. W1 150mm Thick Precast Concrete Panel Wall. Class 2 - Trowel Finish. Painted. W2 200mm Thick Precast Concrete Panel Wall. Class 2 - Trowel Finish. Painted. W3 150mm Steel Stud Partition System. Studs at 600 cts max. External - Fix 35mm furring channels to studwork and line with 9mm Fibre Cement Sheet with expressed joints. Painted. Internal - Line with 12mm Plywood. Internal Grade. Seal. Install Sarking behind FC sheet and R2.5 Insulation Batts to external walls. W4 300x190x90mm Concrete Blockwork in a running bond pattern. 10mm Cement Render to match adjacent piers. Painted. PIN1 - Surfmist. W5 EXTERNAL - Fix 35mm furring channels to substrate framing at 600 cts max. Line with 9mm Fibre Cement Sheet with expressed joints. Painted. RAR - Fix zincalume metal cladding (Fieddars TL-5) to rear of fascia above roof level. Flash onto roofing. W6 EXTERNAL - Fix 35mm furring channels to substrate framing at 600 cts max. Line with 9mm Fibre Cement Sheet with expressed joints. Painted.<	P1B			
underside of slab or structure above. Line with 1 layer 13mm flush jointed Plasterboard to one side only. Moisture resistant P/board to all wet areas with 92mm stud @ 450cts max. R1.5 Insulation P4 INTERNAL - 35mm Furring Channel @ 600cts max, lined with 1 layer of 13mm flush jointed plasterboard. P5 Proprietary 2 Hour Fire Rated Plasterboard system - Line with 3 x13mm Fyrchek plasterboard. Full height to underside of floor slab above. Fire sealant to all jourctions and abutting other surfaces. Install as per Manuf system requirements. W1 150mm Thick Precast Concrete Panel Wall. Class 2 - Trowel Finish. Painted. W2 200mm Thick Precast Concrete Panel Wall. Class 2 - Trowel Finish. Painted. W3 150mm Steel Stud Partition System. Studs at 600 cts max. External - Fix 33mm furring channels to studwork and line with 9mm Fibre Cement Sheet with expressed joints. Painted. Internal - Line with 12mm Plywood. Internal Grade. Seal. Install Sarking behind FC sheet and R2.5 Insulation Batts to external walls. W4 390x190x90mm Concrete Blockwork in a running bond pattern. 10mm Cement Render to match adjacent piers. Painted. Theraing at 600 cts max. Line with 9mm Fibre Cement Sheet with expressed joints. Painted. REA - Fix Zistom furring channels to stacia framing at 600 cts max. Line with 9mm Fibre Cement Sheet with expressed joints. Painted. REA - Fix Zistom furring channels to substrate framing at 600 cts max. Line with 9mm Fibre Cement Sheet with expressed joints. Painted.	P2	underside of slab or structure above. Liné with 1 layer 13mm flush jointed Plasterboard both sides. Moisture resistant P/board to all wet areas with 92mm stud @ 450cts max. R1.5 Insulation Batts to all internal		
13mm flush jointed plasterboard. P5 Proprietary 2 Hour Fire Rated Plasterboard system - Line with 3 x13mm Fyrchek plasterboard. Full height to underside of floor slab above. Fire sealant to all junctions and abutting other surfaces. Install as per Manuf' system requirements. W1 150mm Thick Precast Concrete Panel Wall. Class 2 - Trowel Finish. Painted. W2 200mm Thick Precast Concrete Panel Wall. Class 2 - Trowel Finish. Painted. W3 150mm Steel Stud Partition System. Studs at 600 cts max. External - Fix 35mm furing channels to studwork and line with 9mm Fibre Cement Sheet with expressed joints. Painted. Internal - Line with 17mm Plywood. Internal Grade. Seal. Install Sarking behind FC sheet and R2.5 Insulation Batts to external walls. W4 390x190x90mm Concrete Blockwork in a running bond pattern. 10mm Cement Render to match adjacent piers. Painted. PINT - Surfmist. W5 EXTERNAL - Fix 35mm furring channels to facia framing at 600 cts max. Line with 9mm Fibre Cement Sheet with expressed joints. Painted. REAR - Fix zincalume metal cladding (Fielders TL-5) to rear of fascia above roof level. Flash onto roofing. W6 EXTERNAL - Fix 35mm furring channels to substrate framing at 600 cts max. Line with 9mm Fibre Cement Sheet with expressed joints. Painted.	P3	underside of slab or structure above. Line with 1 layer 13mm flush jointed Plasterboard to one side only. Moisture resistant P/board to all		
Fyrchek plasterboard. Full height to underside of floor slab above. Fire sealant to all junctions and abutting other surfaces. Install as per Manuf' system requirements. W1 150mm Thick Precast Concrete Panel Wall. Class 2 - Trowel Finish. Painted. W2 200mm Thick Precast Concrete Panel Wall. Class 2 - Trowel Finish. Painted. W3 150mm Steel Stud Partition System. Studs at 600 cts max. External - Fix 35mm furring channels to studwork and line with 9mm Fibre Cement Sheet with expressed joints. Painted. I-Line with 17mm Plywood. Internal Grade. Seal. Install Sarking behind FC sheet and R2.5 Insulation Batts to external walls. W4 300x190x90mm Concrete Blockwork in a running bond pattern. 10mm Cement Render to match adjacent piers. Painted. JPT1 - Surfnist. W5 EXTERNAL - Fix 35mm furring channels to facia framing at 600 cts max. Line with 9mm Fibre Cement Sheet with expressed joints. Painted. W6 EXTERNAL - Fix 35mm furring channels to substrate framing at 600 cts max. Line with 9mm Fibre cement Sheet with expressed joints. Painted. W6 EXTERNAL - Fix 35mm furring channels to substrate framing at 600 cts max. Line with 9mm Fibre cement Sheet with expressed joints. Painted.	P4			
Painted. W2 200mm Thick Precast Concrete Panel Wall. Class 2 - Trowel Finish. Painted. W3 150mm Steel Stud Partition System. Studs at 600 cts max. External - Fix 35mm furring channels to studwork and line with 9mm Fibre Cement Sheet with expressed joints. Painted. Internal - Line with 12mm Plywood. Internal Grade. Seal. Install Sarking behind FC sheet and R2.5 Insulation Batts to external walls. W4 390x190x90mm Concrete Blockwork in a running bond pattern. 10mm Cement Render to match adjacent piers. Painted: PNT1 - Surfmist. W5 EXTERNAL - Fix 35mm furring channels to facia framing at 600 cts max. Line with 9mm Fibre Cement Sheet with expressed joints. Painted. REAR - Fix zincalume metal cladding (Fielders TL-5) to rear of fascia above roof level. Flash onto roofing. W6 EXTERNAL - Fix 35mm furring channels to substrate framing at 600 cts max. Line with 9mm Fibre Cement Sheet with expressed joints. Painted.	P5	Fyrchek plasterboard. Full height to underside of floor slab above. Fire sealant to all junctions and abutting other surfaces. Install as per Manuf		
Painted. W3 150mm Steel Stud Partition System. Studs at 600 cts max. External - Fix 33mm furring channels to studwork and line with 9mm Fibre Cement Sheet with expressed joints. Painted. Internal - Line with 12mm Plywood. Internal Grade. Seal. Install Sarking behind FC sheet and R2.5 Insulation Batts to external walls. W4 390x190x90mm Concrete Blockwork in a running bond pattern. 10mm Cement Render to match adjacent piers. Painted: PNI1 - Surfmist. W5 EXTERNAL - Fix 35mm furring channels to fascia framing at 600 cts max. Line with 9mm Fibre Cement Sheet with expressed joints. Painted. REAR - Fix zincalume metal cladding (Fielders TL-5) to rear of fascia above roof level. Flash onto roofing. W6 EXTERNAL - Fix 35mm furring channels to substrate framing at 600 cts max. Line with 9mm Fibre Cement Sheet with expressed joints. Painted. REAR - Fix zincelume metal cladding (Fielders TL-5) to rear of fascia above roof level. Flash onto roofing.	W1			
35mm furring channels to studwork and line with 9mm Fibre Cement Sheet with expressed joints. Painted. Internal - Line with 17mm Plywood. Internal Grade. Seal. Install Sarking behind FC sheet and R2.5 Insulation Batts to external walls. W4 30x190x90mm Concrete Blockwork in a running bond pattern. 10mm Cement Render to match adjacent piers. Painted: PNT1 - Surfmist. W5 EXTERNAL - Fix 35mm furring channels to facia framing at 600 cts max. Line with 9mm Fibre Cement Sheet with expressed joints. Painted. REAR - Fix zincalume metal cladding (Fielders TL-5) to rear of fascia above roof level. Flash onto roofing. W6 EXTERNAL - Fix 35mm furring channels to substrate framing at 600 cts max. Line with 9mm Fibre Cement Sheet with expressed joints. Painted.	W2			
Cement Render to match adjacent piers. Painted. PNT1 - Surfmist. W5 EXTERNAL - Fix 35mm furring channels to fascia framing at 600 cts max. Line with 9mm Fibre Cement Sheet with expressed joints. Painted. REAR - Fix zincalume metal cladding (Fielders TL-5) to rear of fascia above roof level. Flash onto roofing. W6 EXTERNAL - Fix 35mm furring channels to substrate framing at 600 cts max. Line with 9mm Fibre Cement Sheet with expressed joints. Painted.	W3	Sheet with expressed joints. Painted. Internal - Line with 12mm Plywood. Internal Grade. Seal. Install Sarking behind FC sheet and R2.5 Insulation Batts to external walls.		
max. Line with 9mm Fibre Cernent Sheet with expressed joints. Painted. REAR - Fix zincalume metal cladding (Fielders TL-5) to rear of fascia above roof level. Flash onto roofing. W6 EXTERNAL - Fix 35mm furring channels to substrate framing at 600 cts max. Line with 9mm Fibre Cernent Sheet with expressed joints. Painted.	W4	Cement Render to match adjacent piers. Painted: PNT1 - Surfmist.		
max. Line with 9mm Fibre Cement Sheet with expressed joints. Painted.	W5	max. Line with 9mm Fibre Cement Sheet with expressed joints. Painted. REAR - Fix zincalume metal cladding (Fielders TL-5) to rear of fascia		
	W6	max. Line with 9mm Fibre Cement Sheet with expressed joints. Painted.		
Tag . Description .	Tag	Description		

Tag .	Description .	
AL-ANGLE	Aluminium Angle, to match glazing framing.	
BG-01	600 W x 150mm Deep Box gutter folded from 0.8mm zincalume sheeting. Spandek gutter board on adjustable box gutter support straps at 900 cts max. 1 in 200 Fall to sumps.	
C1	Selected Carpet tiles	
DPM	Damp proof membrane	
EG1	Fieders "Urbis" Eaves Gutter. Colorbond Surfmist to match existing adjoining Building.	
FL	Flashing. Colorbond Surmist where visible. Zincalume where not visible.	
FL-1	Flashing Colorbond to match existing adjoining Building. Colour: Surfmist.	
GALV.ANGLE	50x50x1.2mm Folded Galvanised Angle	
PC	Parapet wall capping Colorbond to match existing adjoining Building. Colour: Surfmist.	
RFS-01	Fielders TL-5 Zincalume Metal roof cladding, to match existing adjoining Building.	
S-CONC	New Concrete Slab / Footing, as per Struct.Eng.Design.	
SEALANT	Continuous sealant	
SOG1	New Concrete Slab / Footing on ground, as per Struct.Eng.Design.	
SS-1	New Suspended Concrete Slab, as per Struct.Eng.Design.	
ST-BM	Structural Steel Framing (Beam / Rafter / Window Head), as per Struct.Eng.Design.	
SUB-SILL	Proprietary Subsill to glazing framing system	
TMB-SP_FLOOR	Proprietary timber sprung sports flooring system, as per Flooring Contractors design. Allow 100mm setdown to concrete floor slab.	
VPM	Vapour Permeable Membrane	
	(F3)	

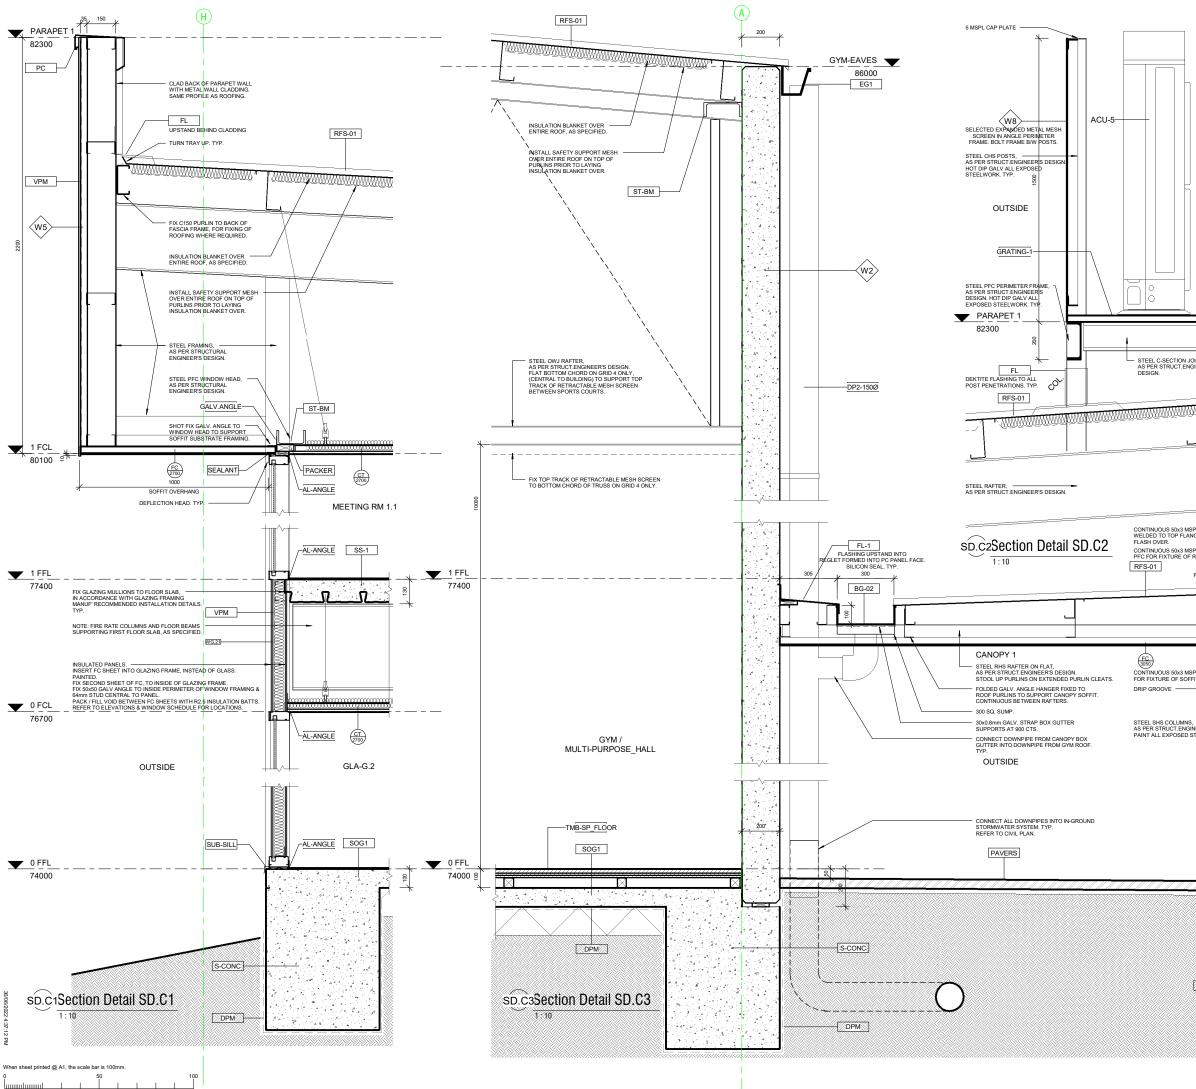Contractors must verify all dimensions at the jo s before commencing work or making shop drawings. Not for Construction until approved by Statuto




		vvali Schedule
	Wall Type P1	Description INTERNAL - 64mm Steel stud partition system. Studs @ 600cts max. 20mm Airgap against panel. Line internally with 1 layer 13mm flush jointed plasterboard. Moisture resistant P/board to all wet areas with studs @ 450 cts max. R2.5 Insulation batts to all external walls.
	P1A	Internally with 1 layer of 13mm flush jointed plasterboard.
7	P1B	INTERNAL - 64mm Steel stud partition system. Studs @ 600cts max
	P2	lined internally with 1 layer of 12mm Plywood. Internal grade. Sealed. INTERNAL - 92mm Steel stud partition system. Studs @ 600cts max to underside of slab or structure above. Line with 1 layer 13mm flush jointed Plasterboard both sides. Moisture resistant P/board to all wet
	P3	areas with 92mm stud @ 450cts max. R1.5 Insulation Batts to all internal walls. Typ. INTERNAL - 92mm Steel stud partition system. Studs @ 600cts max to underside of slab or structure above. Line with 1 layer 13mm flush
	P4	jointed Plasterboard to one side only. Moisture resistant P/board to all wet areas with 92mm stud @ 450cts max. R1.5 Insulation INTERNAL - 35mm Furring Channel @ 600cts max, lined with 1 layer of
	P5	13mm flush jointed plasterboard. Proprietary 2 Hour Fire Rated Plasterboard system - Line with 3 x13mm Fyrchek plasterboard. Full height to underside of floor slab above. Fire scalart to all impleme and abutting there are forces install as pace.
	W1	sealant to all junctions and abutting other surfaces. Install as per Manuf system requirements. 150mm Thick Precast Concrete Panel Wall. Class 2 - Trowel Finish.
	W2	Painted. 200mm Thick Precast Concrete Panel Wall. Class 2 - Trowel Finish.
	W3	Painted. 150mm Steel Stud Partition System. Studs at 600 cts max. External - Fix 35mm furring channels to studwork and line with 9mm Fibre Cement Sheet with expressed joints. Painted. Internal - Line with 12mm Plywood. Internal Grade. Seal. Install Sarking behind FC sheet and R2.5
J	W4	Insulation Batts to external walls. 390x190x90mm Concrete Blockwork in a running bond pattern. 10mm
<u> </u>	W5	Cement Render to match adjacent piers. Painted: PNT1 - Suffmist. EXTERNAL - Fix 35mm furring channels to fascia framing at 600 cts
		max. Line with 9mm Fibre Cement Sheet with expressed joints. Painted. REAR - Fix zincalume metal cladding (Fielders TL-5) to rear of fascia above roof level. Flash onto roofing.
JOISTS, JGINEER'S	W6	EXTERNAL - Fix 35mm furring channels to substrate framing at 600 cts max. Line with 9mm Fibre Cement Sheet with expressed joints. Painted. Sarking between channels and substrate framing.
	Tag . AL-ANGLE	Description . Aluminium Angle, to match glazing framing.
	BG-02 DP2-150Ø	Autimitum Arge, to match gazing raming. 300 W x 75mm Deep Box gutter folded from 0.8mm zincalume sheeting, 30x0.8mm Galv support straps at 900 cts max. 1 in 200 Fall to sumps. 150 Dia.PVC Downpipe. Connect to in-ground storwater system. Painted: Colorbond Sufmist
	DPM EG1	Damp proof membrane Fieders "Urbis" Eaves Gutter. Colorbond Surfmist to match existing adjoining Building.
	FL FL-1	Flashing. Colorbond Surmist where visible. Zincalume where not visible. Flashing Colorbond to match existing adjoining Building. Colour: Surfmist.
	GALV.ANGLE GRATING-1	50x50x1.2mm Folded Galvanised Angle Selected Galv. floor grating system fixed to structural steel framing / joist with proprietary fixings.
	PACKER PAVERS	Packer / spacer, to suit. Selected segmented pavers on sand sub-base, to match existing pavers. Fall away from building.
	PC PFC	Parapet wall capping Colorbond to match existing adjoining Building. Colour: Surfmist. Steel parallel flange channel, as per Struct.Eng.Design.
	RFS-01 S-CONC	Fielders TL-5 Zincalume Metal roof cladding, to match existing adjoining Building. New Concrete Slab / Footing, as per Struct.Eng.Design.
ISPL UPSTAND,	SEALANT SOG1 SS-1	Continuous sealant New Concrete Slab / Footing on ground, as per Struct.Eng.Design. New Suspended Concrete Slab, as per Struct.Eng.Design.
ANGE OF PFC.	ST-BM SUB-SILL	Structural Steel Framing (Beam / Rafter / Window Head), as per Struct.Eng.Design. Proprietary Subsill to glazing framing system
F ROOF CLADDING.	TMB-SP_FLC OR	Allow 100mm setdown to concrete floor slab.
FLASHING OVER UPSTAND		Vapour Permeable Membrane
		= T
	* 7	(PAINTED)
		= -
ASPL WELDED TO WEB OF PFC		
is		
S, GINEER'S DESIGN. STEELWORK.		
	CO.	9950
^		
		2 Issued for Building Rules Consent 30/06/22 1 Updated Plans 28/06/22
	F.F.L.	Issue Amendments Date Project BCCC Stage 6 - Gym + GLA
		14 Boucaut Avenue, Blakeview. S.A. 5144
	4 4 4 4 4 4 4 4 4 4 4 4 4 4 4 4 4 4 4	SECTION DETAILS - SHEET 2
		TONKIN design SCHUTZ build
S-CONC	4,	16-22 Erudina Ave, Edwardstown S.A. 5039 Ph. (08) 8277 0111 Fax(08) 8277 2255 Commercial - Industrial - Domestc
<u>L'india</u>		
		Date : 21/06/22 Drawn : -
	<u>*</u>	


Wall Schedule

Contractors must verify all dimensions at the jot Not for Construction until approved by Statutory Authorites before commencing work or making shop drawings.

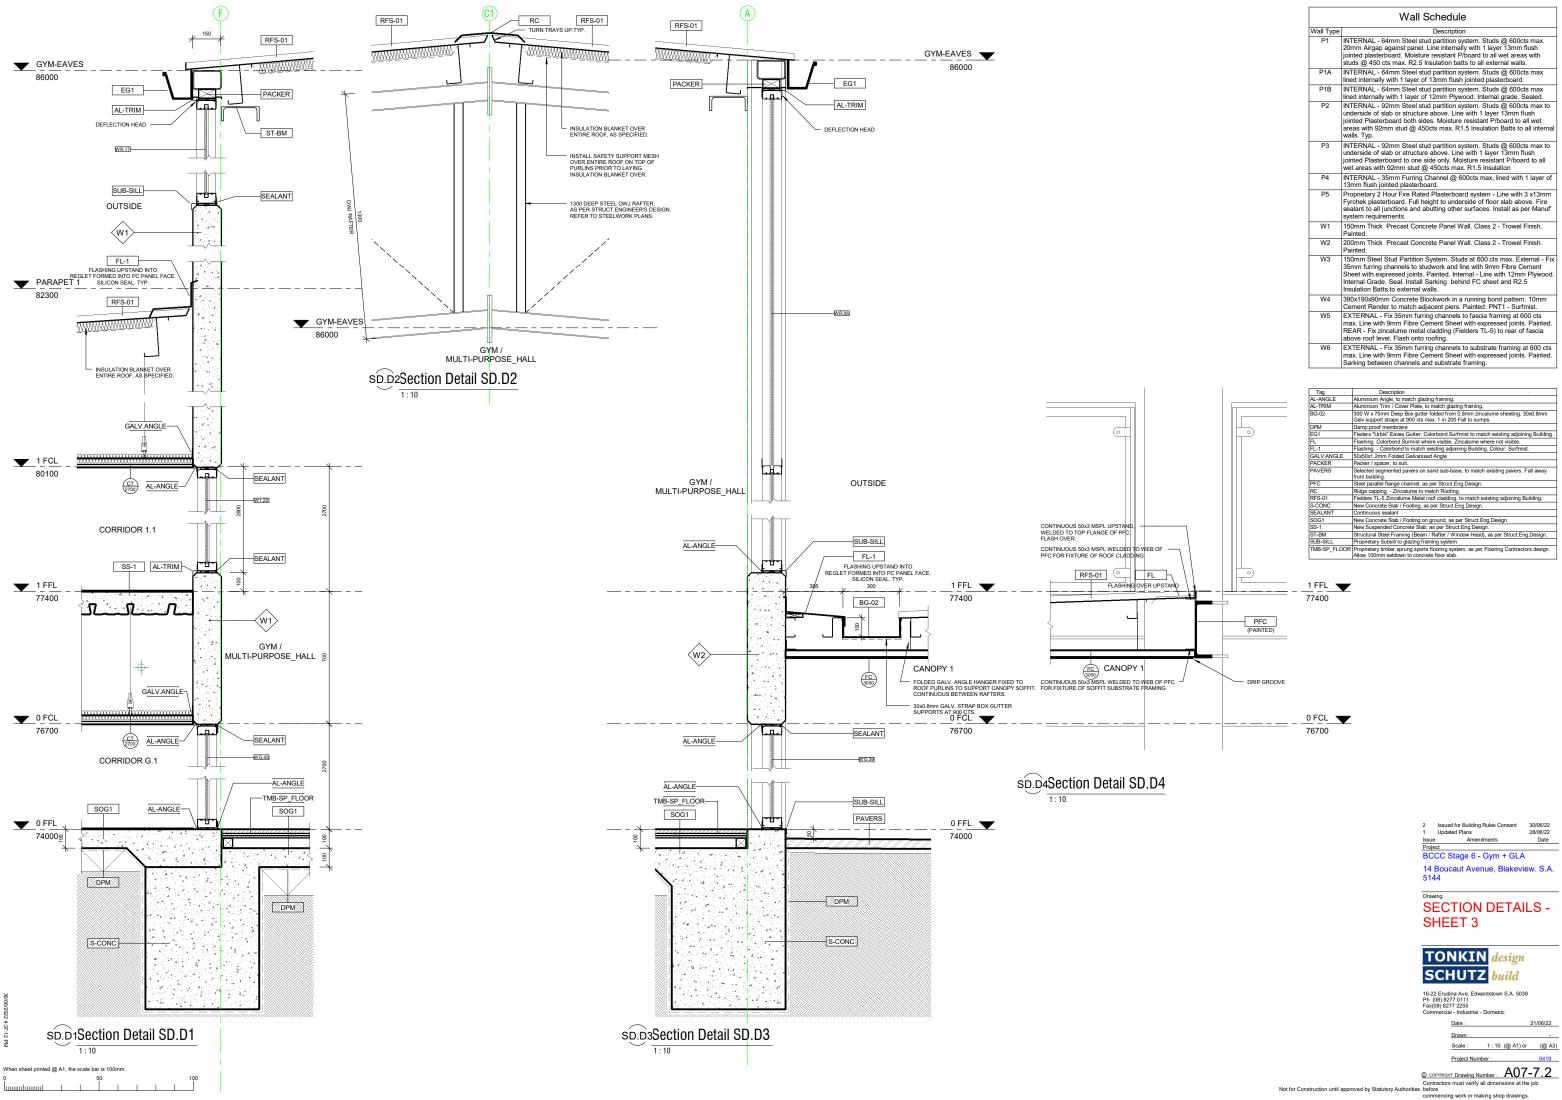[©] COPYRIGHT Drawing Number : A07-6.2



Wall Schedule		
Wall Type	Description	
P1	INTERNAL - 64mm Steel stud partition system. Studs @ 600cts max. 20mm Airgap against panel. Line internally with 1 layer 13mm flush jointed plasterboard. Moisture resistant Pboard to all wet areas with studs @ 450 cts max. R2.5 Insulation batts to all external walls.	
P1A	INTERNAL - 64mm Steel stud partition system. Studs @ 600cts max lined internally with 1 layer of 13mm flush jointed plasterboard.	
P1B	INTERNAL - 64mm Steel stud partition system. Studs @ 600cts max lined internally with 1 layer of 12mm Plywood. Internal grade. Sealed.	
P2	INTERNAL - 92mm Steel stud partition system. Studs @ 600cts max to underside of slab or structure above. Line with 1 layer 13mm flush jointed Plasterboard both sides. Moisture resistant P/board to all wet areas with 92mm stud @ 450cts max. R1.5 Insulation Batts to all internal walls. Typ.	
P3	INTERNAL - 92mm Steel stud partition system. Studs @ 600cts max to underside of slab or structure above. Line with 1 layer 13mm flush jointed Plasterboard to one side only. Moisture resistant P/board to all wet areas with 92mm stud @ 450cts max. R1.5 Insulation	
P4	INTERNAL - 35mm Furring Channel @ 600cts max, lined with 1 layer of 13mm flush jointed plasterboard.	
P5	Proprietary 2 Hour Fire Rated Plasterboard system - Line with 3 x13mm Fyrchek plasterboard. Full height to underside of floor slab above. Fire sealant to all junctions and abutting other surfaces. Install as per Manuf system requirements.	
W1	150mm Thick Precast Concrete Panel Wall. Class 2 - Trowel Finish. Painted.	
W2	200mm Thick Precast Concrete Panel Wall. Class 2 - Trowel Finish. Painted.	
W3	150nm Steel Stud Partition System. Studs at 600 cts max. External - Fix 36mm furing channels to studwork and line with 9mm Fibre Cement Sheet with expressed joints. Painted. Internal - Line with 12mm Plywood. Internal Grade. Seal. Install Sarking behind FC sheet and R2.5 Insulation Batts to external walls.	
W4	390x190x90mm Concrete Blockwork in a running bond pattern. 10mm Cement Render to match adjacent piers. Painted: PNT1 - Surfmist.	
W5	EXTERNAL - Fix 35mm furring channels to fascia framing at 600 cts max. Line with 9mm Fibre Cement Sheet with expressed joints. Painted. REAR - Fix zincalume metal cladding (Fielders TL-5) to rear of fascia above roof level. Flash onto roofing.	
W6	EXTERNAL - Fix 35mm furring channels to substrate framing at 600 cts max. Line with 9mm Fibre Cement Sheet with expressed joints. Painted. Sarking between channels and substrate framing	

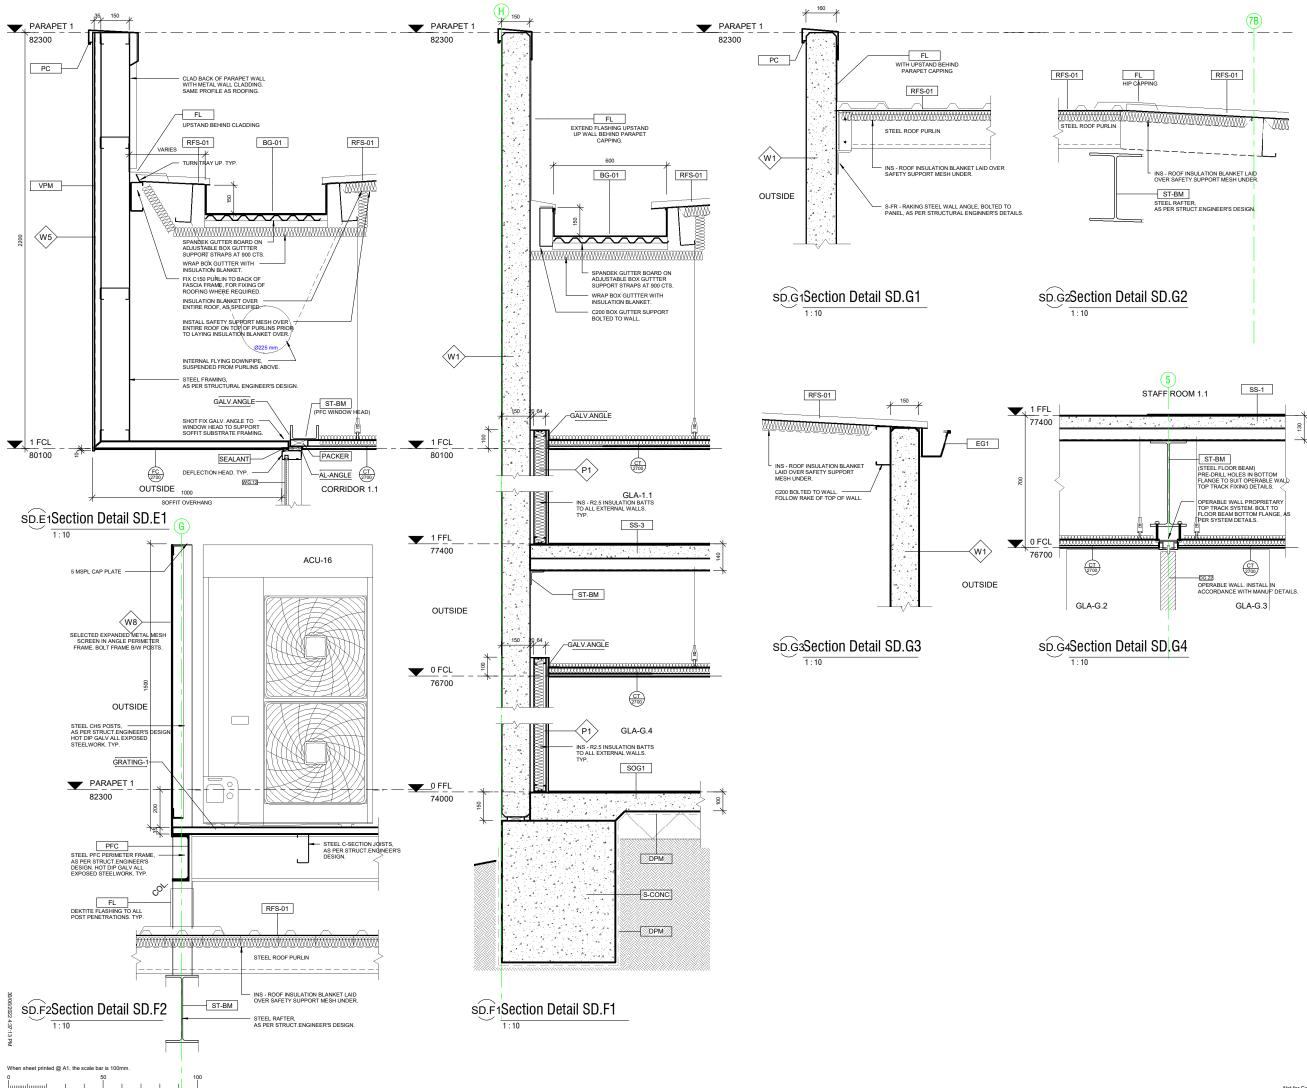


Wall Schedule			
Wall Type	Description		
P1	INTERNAL - 64mm Steel stud partition system. Studs @ 600cts max. 20mm Airgap against panel. Line internally with 1 layer 13mm flush jointed plasterboard. Moisture resistant Plobard to all wet areas with studs @ 450 cts max. R2.5 Insulation batts to all external walls.		
P1A	INTERNAL - 64mm Steel stud partition system. Studs @ 600cts max lined internally with 1 layer of 13mm flush jointed plasterboard.		
P1B	INTERNAL - 64mm Steel stud partition system. Studs @ 600cts max lined internally with 1 layer of 12mm Plywood. Internal grade. Sealed.		
P2	INTERNAL - 92mm Steel stud partition system. Studs @ 600cts max to underside of slab or structure above. Line with 1 layer 13mm flush jointed Plasterboard both sides, Moisture resistant P/board to all wet areas with 92mm stud @ 450cts max. R1.5 Insulation Batts to all internal walls. Typ.		
P3	INTERNAL - 92mm Steel stud partition system. Studs @ 600cts max to underside of slab or structure above. Line with 1 layer 13mm flush jointed Plasterboard to one side only. Moisture resistant P/board to all wet areas with 92mm stud @ 450cts max. R1.5 Insulation		
P4	INTERNAL - 35mm Furring Channel @ 600cts max, lined with 1 layer of 13mm flush jointed plasterboard.		
P5	Proprietary 2 Hour Fire Rated Plasterboard system - Line with 3 x13mm Fyrchek plasterboard. Full height to underside of floor slab above. Fire sealant to all junctions and abutting other surfaces. Install as per Manuf system requirements.		
W1	150mm Thick Precast Concrete Panel Wall. Class 2 - Trowel Finish. Painted.		
W2	200mm Thick Precast Concrete Panel Wall. Class 2 - Trowel Finish. Painted.		
W3	150nm Steel Stud Partition System. Studs at 600 cts max. External - Fix 36nm furring channels to studwork and line with 9nm Fibre Cement Sheet with expressed joints. Painted. Internal - Line with 12nm Plywood. Internal Grade. Beal. Install Sarking behind FC sheet and R2.5 Insulation Batts to external walls.		
W4	390x190x90mm Concrete Blockwork in a running bond pattern. 10mm Cement Render to match adjacent piers. Painted: PNT1 - Surfmist.		
W5	EXTERNAL - Fix 35mm furring channels to fascia framing at 600 cts max. Line with 9mm Fibre Cement Sheet with expressed joints. Painted. REAR - Fix zincalume metal cladding (Fielders TL-5) to rear of fascia above roof level. Flash onto roofing.		
W6	EXTERNAL - Fix 35mm furring channels to substrate framing at 600 cts max. Line with 9mm Fibre Cement Sheet with expressed joints. Painted. Sarking between channels and substrate framing.		

Tag .	Description .	
AL-ANGLE	Aluminium Angle, to match glazing framing.	
BG-01	600 W x 150mm Deep Box gutter folded from 0.8mm zincalume sheeting. Spandek gutter board on adjustable box gutter support straps at 900 cts max. 1 in 200 Fall to sumps.	
DPM	Damp proof membrane	
EG1	Fieders "Urbis" Eaves Gutter. Colorbond Surfmist to match existing adjoining Building.	
FL	Flashing. Colorbond Surmist where visible. Zincalume where not visible.	
GALV.ANGLE	50x50x1.2mm Folded Galvanised Angle	
GRATING-1	Selected Galv. floor grating system fixed to structural steel framing / joist with proprietary fixings.	
PACKER	Packer / spacer, to suit.	
PC	Parapet wall capping Colorbond to match existing adjoining Building. Colour: Surfmist.	
PFC	Steel parallel flange channel, as per Struct.Eng.Design.	
RFS-01	Fielders TL-5 Zincalume Metal roof cladding, to match existing adjoining Building.	
S-CONC	New Concrete Slab / Footing, as per Struct.Eng.Design.	
SEALANT	Continuous sealant	
SOG1	New Concrete Slab / Footing on ground, as per Struct.Eng.Design.	
SS-1	New Suspended Concrete Slab, as per Struct.Eng.Design.	
SS-3	New Suspended Concrete Slab, as per Struct.Eng.Design.	
ST-BM	Structural Steel Framing (Beam / Rafter / Window Head), as per Struct.Eng.Design.	
VPM	Vapour Permeable Membrane	

2 Issued for Building Rules Consent 1 Updated Plans Issue Amendments	30/06/22 28/06/22 Date
Project	
BCCC Stage 6 - Gym + GLA	κ
14 Boucaut Avenue, Blakev 5144	ew. S.A.
Drawing	
SECTION DETA	LS -
SHEET 4	
SHELT 4	
TONKIN design	
SCHUTZ build	
16-22 Erudina Ave, Edwardstown S.A. 503 Ph (08) 8277 0111 Fax(08) 8277 2255 Commercial - Industrial - Domestc	39
Date :	21/06/22
Drawn :	-
Scale : 1 : 10 (@ A1)	or (@ A3)
Project Number :	0419
	7-8.2

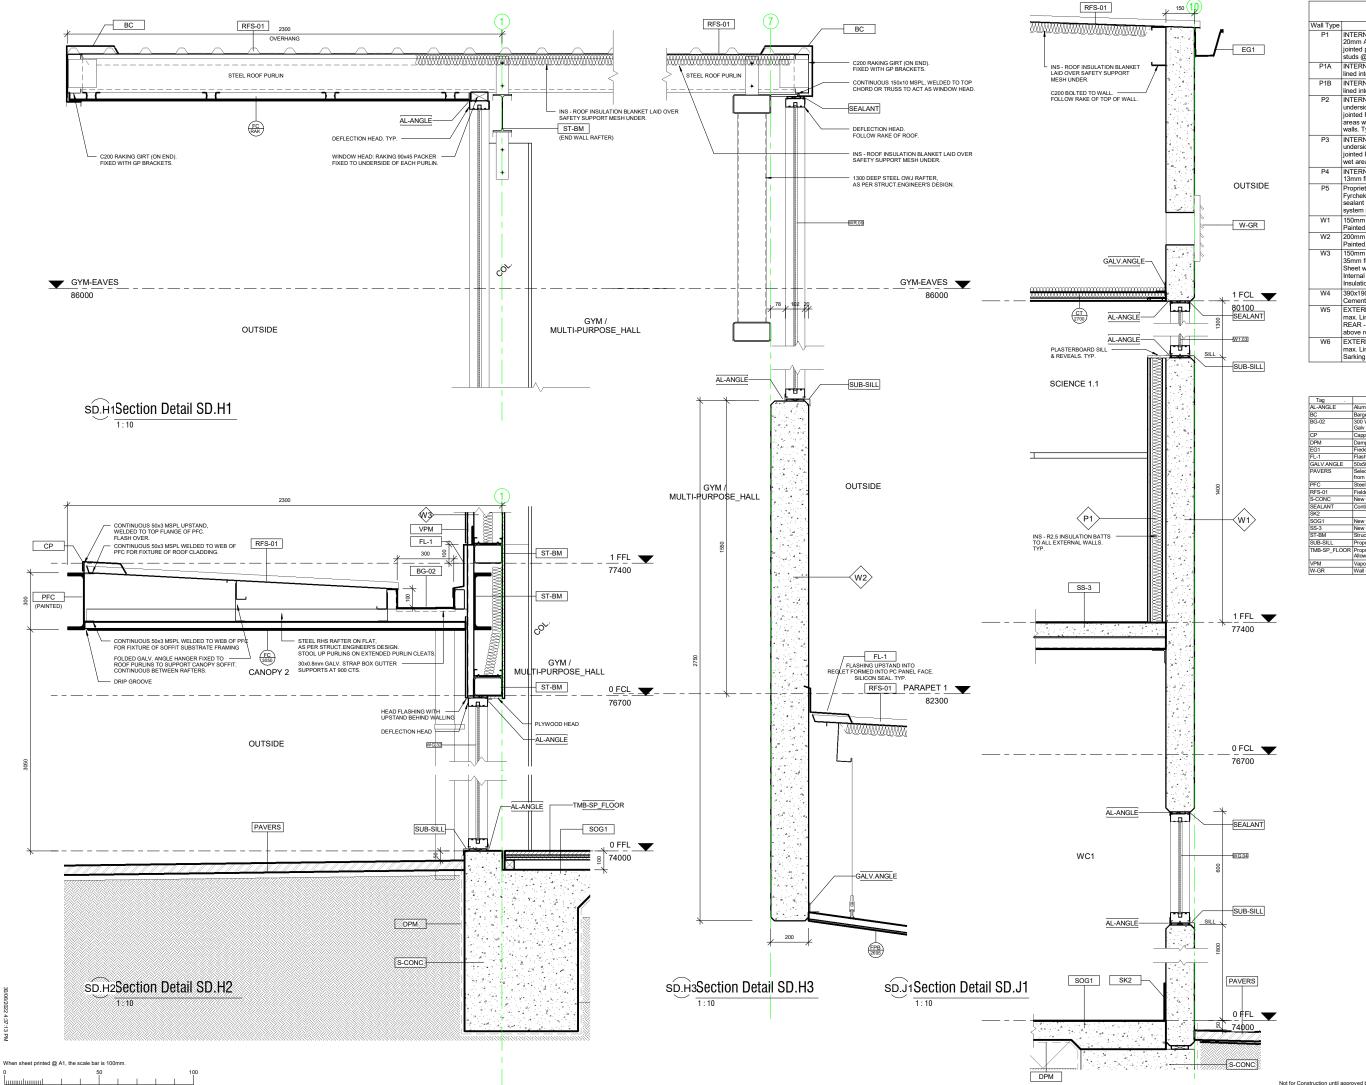© COPYRIGHT Drawing Number : A07-8.2 Contractors must verify all dimensions at the job Not for Construction until approved by Statutory Authonites before commencing work or making shop drawings.




	Wall Schedule
Vall Type	Description
P1	INTERNAL - 64mm Steel stud partition system. Studs @ 600cts ma 20mm Airgap against panel. Line internally with 1 layer 13mm flush jointed plasterboard. Moisture resistant Plobard to all wet areas with studs @ 450 cts max. R2.5 Insulation batts to all external walls.
P1A	INTERNAL - 64mm Steel stud partition system. Studs @ 600cts ma: lined internally with 1 layer of 13mm flush jointed plasterboard.
P1B	INTERNAL - 64mm Steel stud partition system. Studs @ 600cts mail lined internally with 1 layer of 12mm Plywood. Internal grade. Sealed
P2	INTERNAL - 92mm Steel stud partition system. Studs @ 600cts ma: underside of slab or structure above. Line with 1 layer 13mm flush jointed Plasterboard both sides. Moisture resistant P/board to all wel areas with 92mm stud @ 450cts max. R1.5 insulation Batts to all inti walls. Typ.
P3	INTERNAL - 92mm Steel stud partition system. Studs @ 600cts ma: underside of slab or structure above. Line with 1 layer 13mm flush jointed Plasterboard to one side only. Moisture resistant P/board to a wet areas with 92mm stud @ 450cts max. R1.5 Insulation
P4	INTERNAL - 35mm Furring Channel @ 600cts max, lined with 1 laye 13mm flush jointed plasterboard.
P5	Proprietary 2 Hour Fire Rated Plasterboard system - Line with 3 x13 Fyrchek plasterboard. Full height to underside of floor slab above. F sealant to all junctions and abutting other surfaces. Install as per Ma system requirements.
W1	150mm Thick Precast Concrete Panel Wall. Class 2 - Trowel Finish Painted.
W2	200mm Thick Precast Concrete Panel Wall. Class 2 - Trowel Finish Painted.
W3	150mm Steel Stud Partition System. Studs at 600 cts max, External 35mm furring channels to studwork and line with 9mm Fibre Cement Sheet with expressed joints. Painted. Internal - Line with 12mm Plyw Internal Grade. Seal. Install Sarking behind FC sheet and R2.5 Insulation Batts to external walls.
W4	390x190x90mm Concrete Blockwork in a running bond pattern. 10m Cement Render to match adjacent piers. Painted: PNT1 - Surfmist.
W5	EXTERNAL - Fix 35mm furring channels to fascia framing at 600 cts max. Line with 9mm Fibre Cement Sheet with expressed joints. Pair REAR - Fix zincalume metal cladding (Fielders TL-5) to rear of fasci above roof level. Flash onto roofing.
W6	EXTERNAL - Fix 35mm furring channels to substrate framing at 600 max. Line with 9mm Fibre Cement Sheet with expressed joints. Pain Sarking between channels and substrate framing.

Tag .	Description .
AL-ANGLE	Aluminium Angle, to match glazing framing.
BC	Barge capping Colorbond Surfmist to match existing adjoining Building.
BG-02	300 W x 75mm Deep Box gutter folded from 0.8mm zincalume sheeting. 30x0.8mm Galv support straps at 900 cts max. 1 in 200 Fall to sumps.
CP	Capping Colorbond to match existing adjoining Building. Colour: Surfmist.
DPM	Damp proof membrane
EG1	Fieders "Urbis" Eaves Gutter. Colorbond Surfmist to match existing adjoining Building.
FL-1	Flashing Colorbond to match existing adjoining Building. Colour: Surfmist.
GALV.ANGLE	50x50x1.2mm Folded Galvanised Angle
PAVERS	Selected segmented pavers on sand sub-base, to match existing pavers. Fall away from building.
PFC	Steel parallel flange channel, as per Struct.Eng.Design.
RFS-01	Fielders TL-5 Zincalume Metal roof cladding, to match existing adjoining Building.
S-CONC	New Concrete Slab / Footing, as per Struct.Eng.Design.
SEALANT	Continuous sealant
SK2	
SOG1	New Concrete Slab / Footing on ground, as per Struct.Eng.Design.
SS-3	New Suspended Concrete Slab, as per Struct.Eng.Design.
ST-BM	Structural Steel Framing (Beam / Rafter / Window Head), as per Struct.Eng.Design.
SUB-SILL	Proprietary Subsill to glazing framing system
TMB-SP_FLOOR	Proprietary timber sprung sports flooring system, as per Flooring Contractors design. Allow 100mm setdown to concrete floor slab.
VPM	Vapour Permeable Membrane
W-GR	Wall mounted grille. Refer to Mechanical drawings



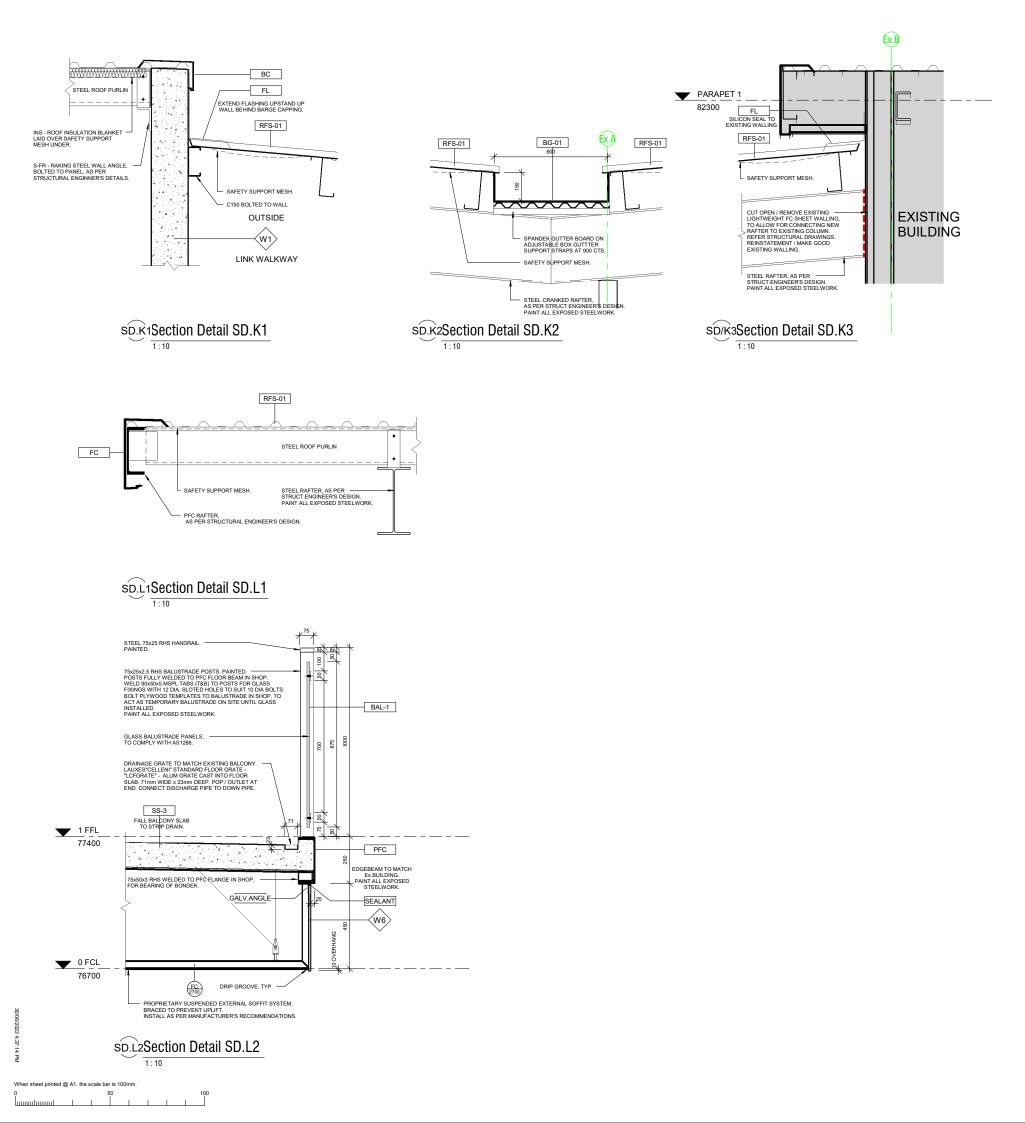Contractors must verify all dimensions at the job before commencing work or making shop drawings.





Wall Schedule		
Wall Type	Description	
P1	INTERNAL - 64mm Steel stud partition system. Studs @ 600cts max. 20mm Airgap against panel. Line internally with 1 layer 13mm flush jointed plasterboard. Moisture resistant P/board to all wet areas with studs @ 450 cts max. R2.5 Insulation batts to all external walls.	
P1A	INTERNAL - 64mm Steel stud partition system. Studs @ 600cts max lined internally with 1 layer of 13mm flush jointed plasterboard.	
P1B	INTERNAL - 64mm Steel stud partition system. Studs @ 600cts max lined internally with 1 layer of 12mm Plywood. Internal grade. Sealed.	
P2	INTERNAL - 92mm Steel stud partition system. Studs @ 600cts max to underside of slab or structure above. Line with 1 layer 13mm flush jointed Plasterboard both sides, Moisture resistant P/board to all wet areas with 92mm stud @ 450cts max. R1.5 Insulation Batts to all internal walls. Typ.	
P3	INTERNAL - 92mm Steel stud partition system. Studs @ 600cts max to underside of slab or structure above. Line with 1 layer 13mm flush jointed Plasterboard to one side only. Moisture resistant P/board to all wet areas with 92mm stud @ 450cts max. R1.5 Insulation	
P4	INTERNAL - 35mm Furring Channel @ 600cts max, lined with 1 layer of 13mm flush jointed plasterboard.	
P5	Proprietary 2 Hour Fire Rated Plasterboard system - Line with 3 x13mm Fyrchek plasterboard. Full height to underside of floor slab above. Fire sealant to all junctions and abutting other surfaces. Install as per Manuf system requirements.	
W1	150mm Thick Precast Concrete Panel Wall. Class 2 - Trowel Finish. Painted.	
W2	200mm Thick Precast Concrete Panel Wall. Class 2 - Trowel Finish. Painted.	
W3	150nm Steel Stud Partition System. Studs at 600 cts max. External - Fix 36nm furring channels to studwork and line with 9nm Fibre Cement Sheet with expressed joints. Painted. Internal - Line with 12nm Plywood. Internal Grade. Seal. Install SarKing behind FC sheet and R2.5 Insulation Batts to external walls.	
W4	390x190x90mm Concrete Blockwork in a running bond pattern. 10mm Cement Render to match adjacent piers. Painted: PNT1 - Surfmist.	
W5	EXTERNAL - Fix 35mm furring channels to fascia framing at 600 cts max. Line with 9mm Fibre Cement Sheet with expressed joints. Painted. REAR - Fix zincalume metal cladding (Fielders TL-5) to rear of fascia above roof level. Flash onto roofing.	
W6	EXTERNAL - Fix 35mm furring channels to substrate framing at 600 cts max. Line with 9mm Fibre Cement Sheet with expressed joints. Painted. Sarking between channels and substrate framing.	

Tag .	Description .
BAL-1	Proprietary Glass Balustrade system, in accordance with AS1288. Posts at 2m cts max, welded to PFC.
BC	Barge capping Colorbond Surfmist to match existing adjoining Building.
BG-01	600 W x 150mm Deep Box gutter folded from 0.8mm zincalume sheeting. Spandek gutter board on adjustable box gutter support straps at 900 cts max. 1 in 200 Fall to sumps.
FC	Fascia capping Colorbond Surfmist to match existing adjoining Building.
FL	Flashing. Colorbond Surmist where visible. Zincalume where not visible.
GALV.ANGLE	50x50x1.2mm Folded Galvanised Angle
PFC	Steel parallel flange channel, as per Struct.Eng.Design.
RFS-01	Fielders TL-5 Zincalume Metal roof cladding, to match existing adjoining Building.
SEALANT	Continuous sealant
SS-3	New Suspended Concrete Slab, as per Struct.Eng.Design.



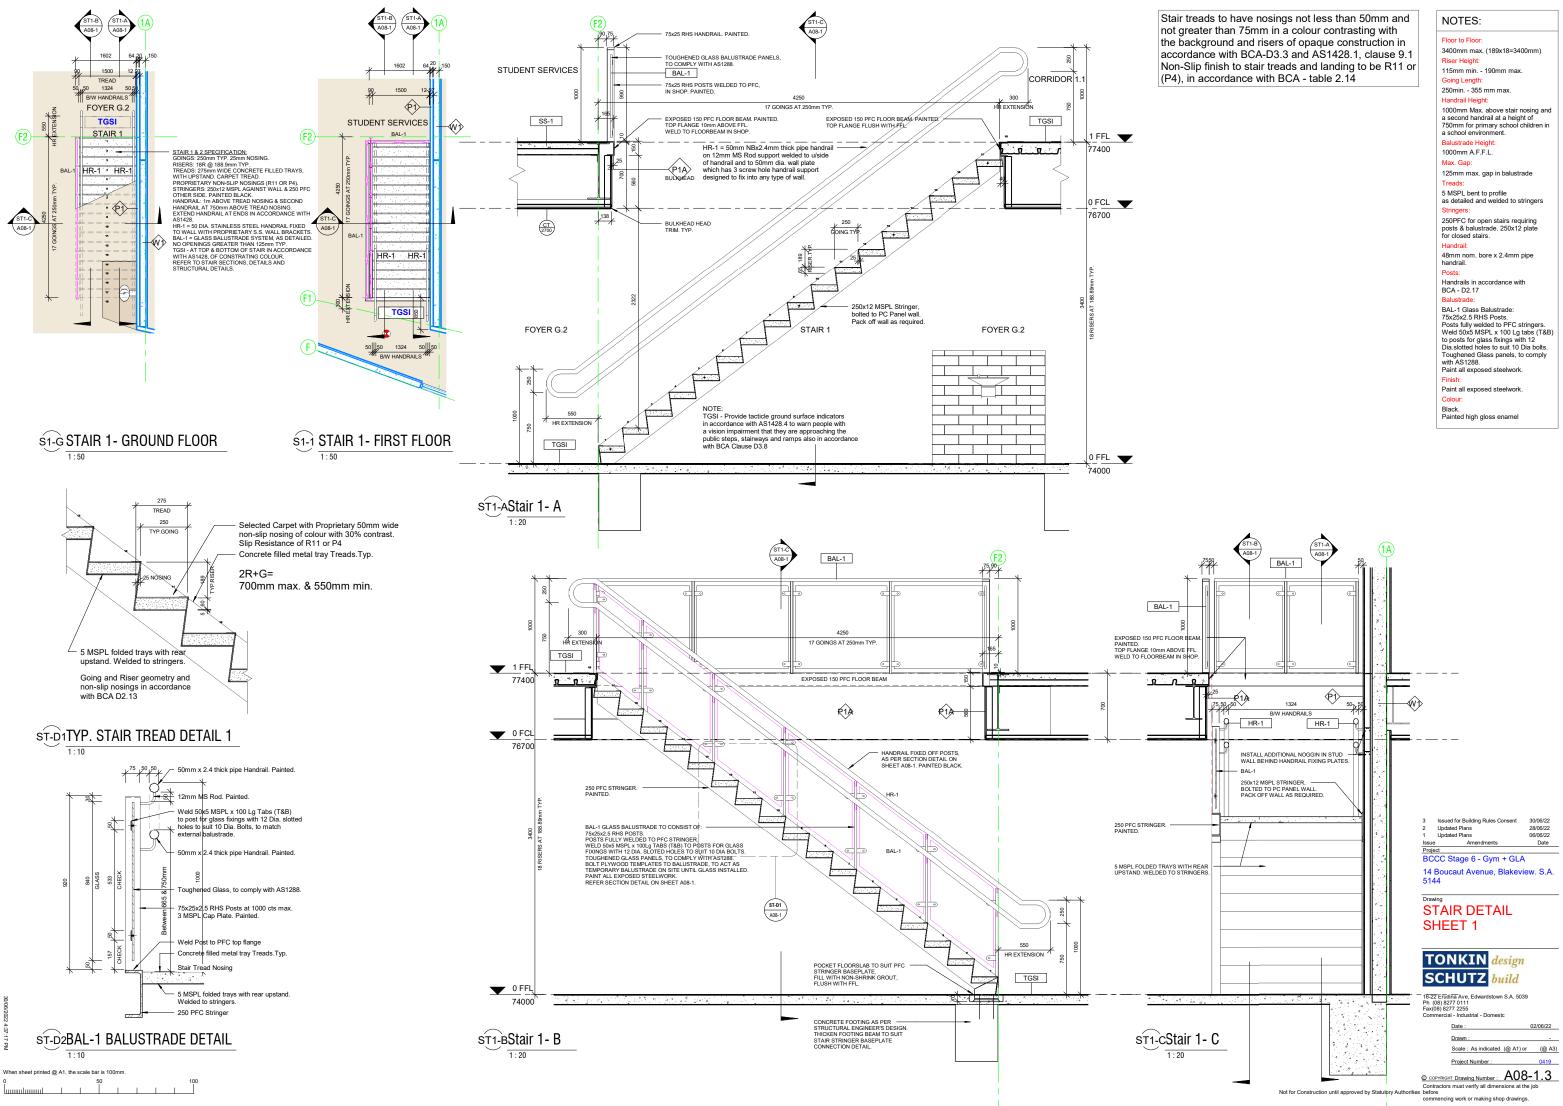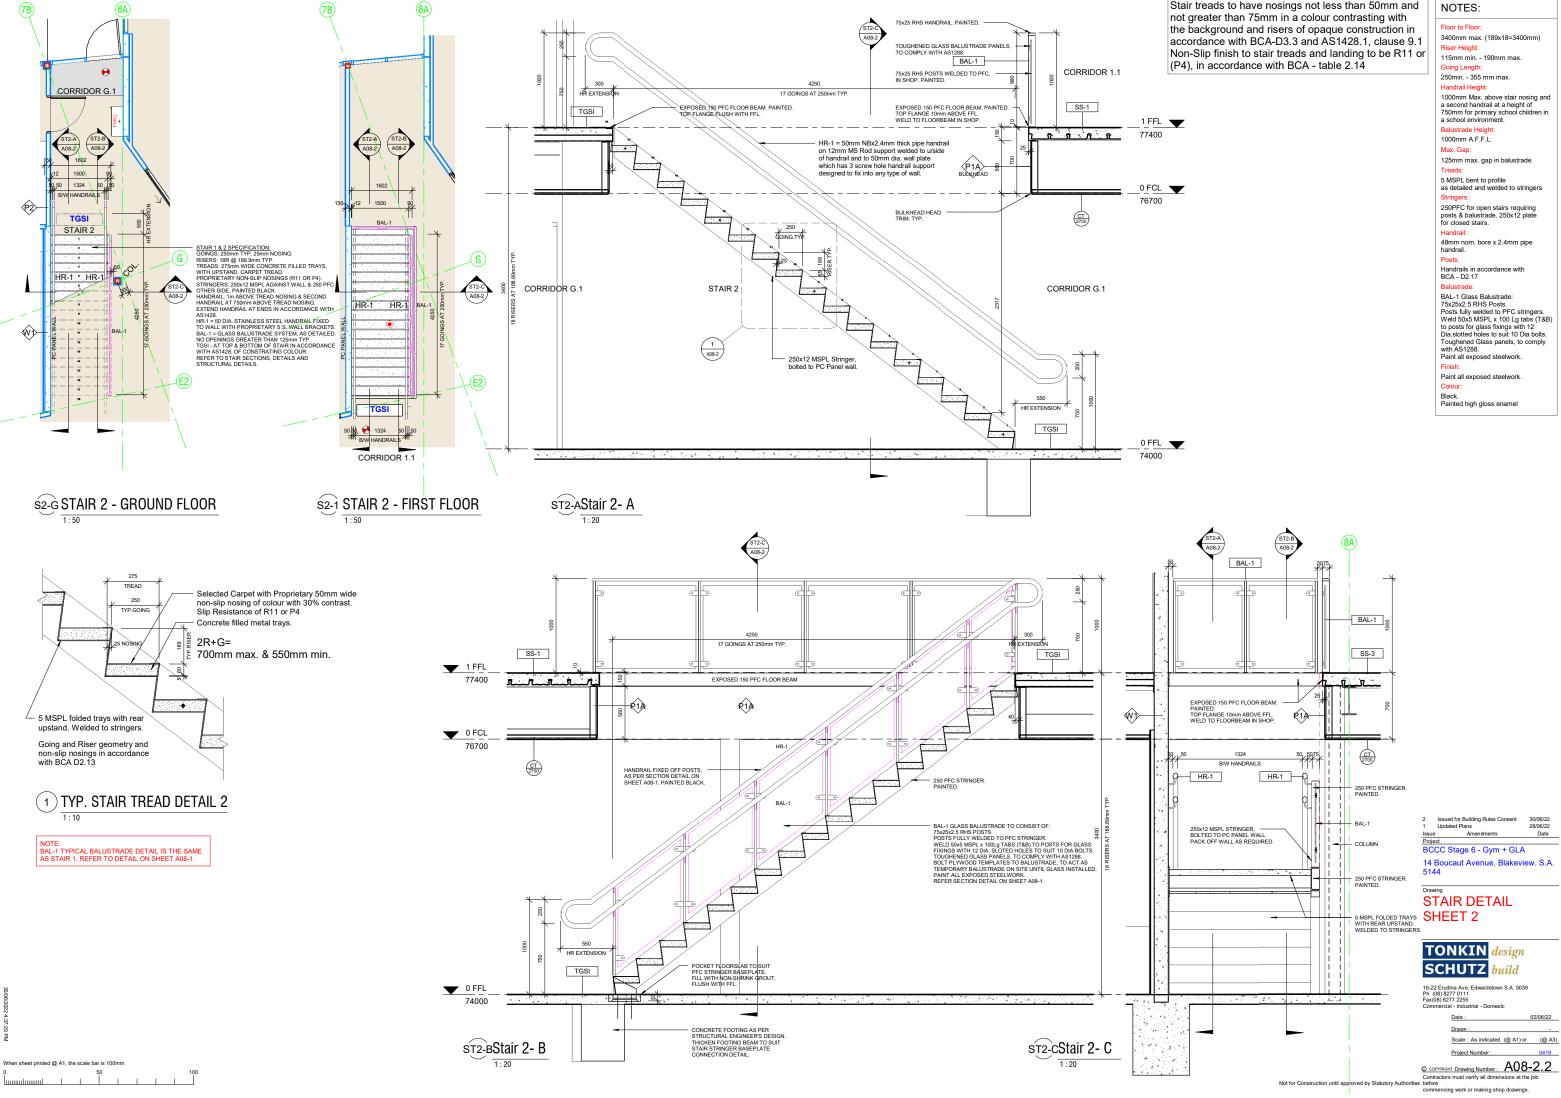
Contractors must verify all dimensions at the job Contractors must verify all dimensions at the job Not for Construction until approved by Statutory Authorities before commencing work or making shop drawings.





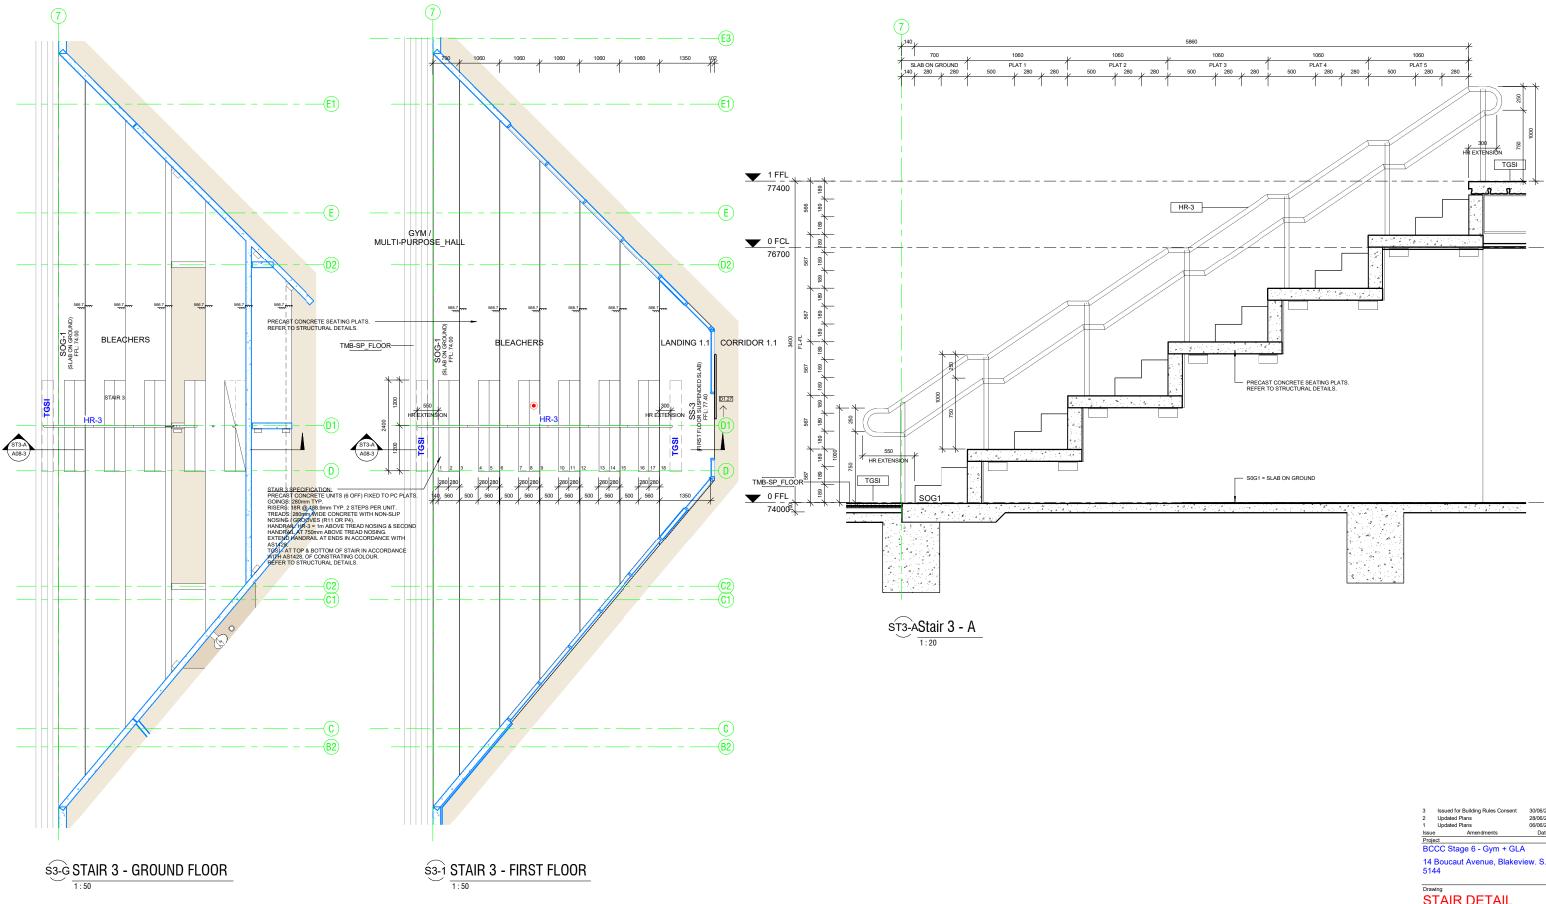Stair treads to have nosings not less than 50mm and





 When sheet printed @ A1, the scale bar is 100mm.


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3 Issued for Building Rules Consent 2 Updated Plans 1 Updated Plans Issue Amendments Project BCCC Stage 6 - Gym + GLA 14 Boucaut Avenue, Blakevie 5144	30/06/22 28/06/22 06/06/22 Date		
Drawing STAIR DETAIL			
SHEET 3			
TONKIN design			
SCHUTZ build			
16-22 Erudina Ave, Edwardstown S.A. 5039 Ph (08) 8277 0111 Fax(08) 8277 2255 Commercial - Industrial - Domestc			
Date :	02/06/22		
Drawn :	<u> </u>		
Scale : As indicated (@ A1) or	(@ A3)		
Project Number :	0419		

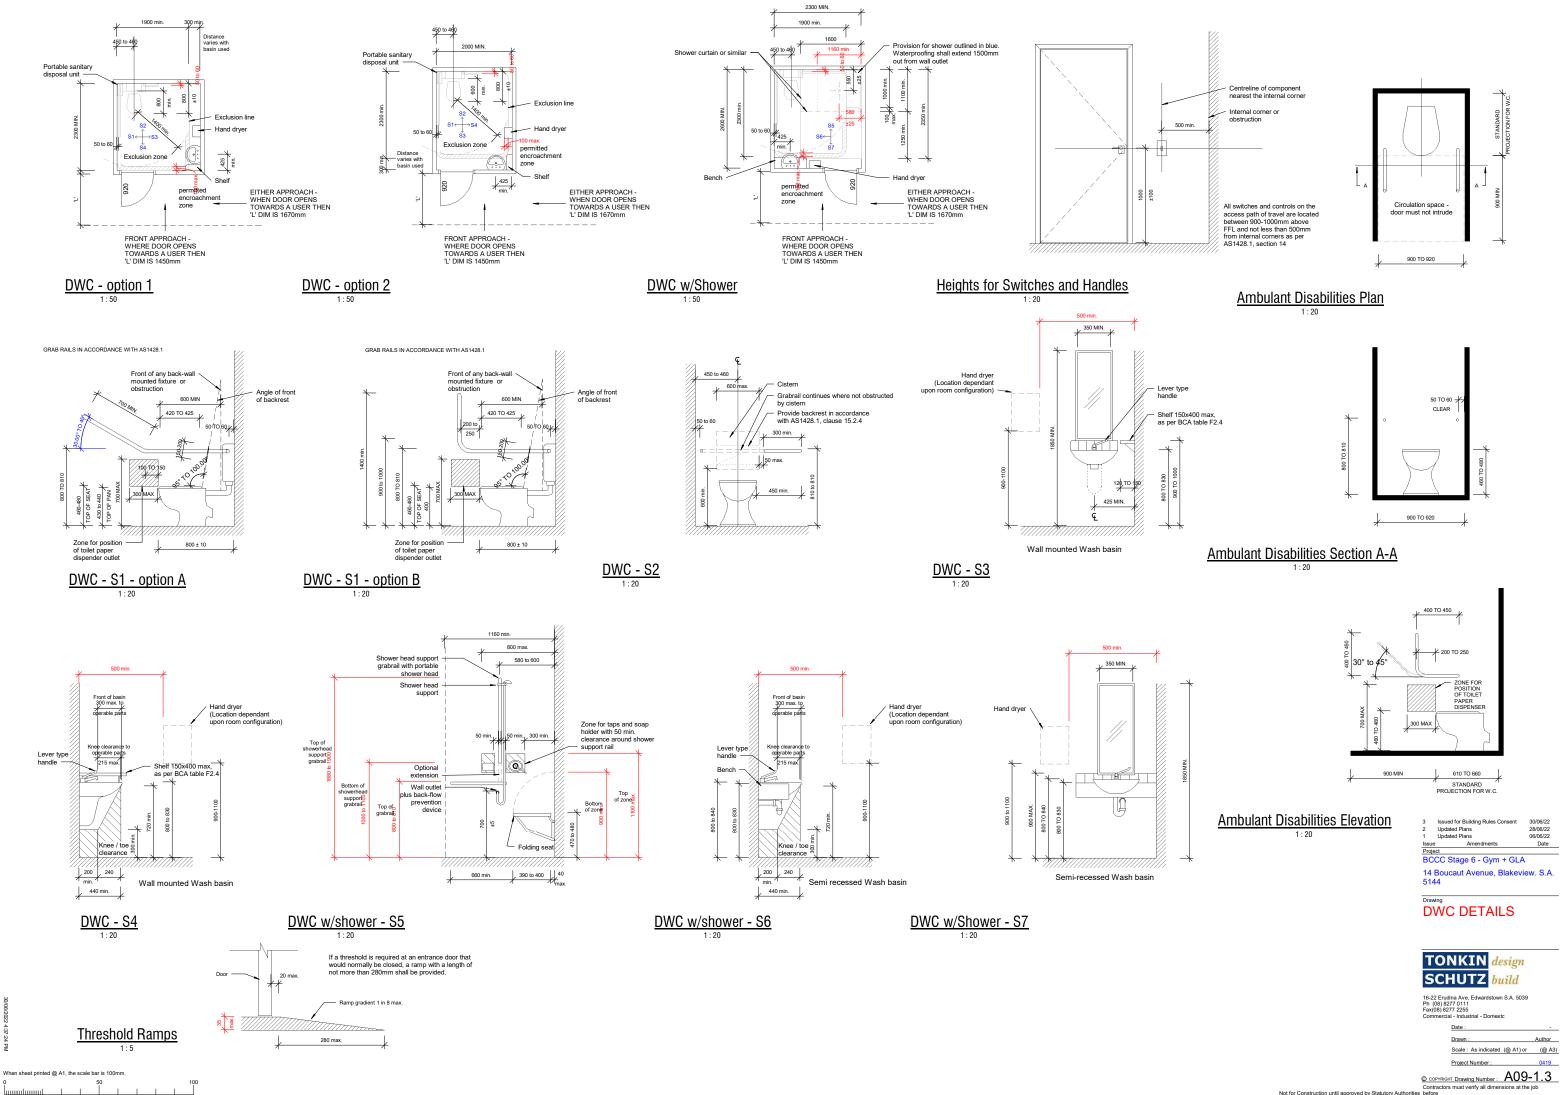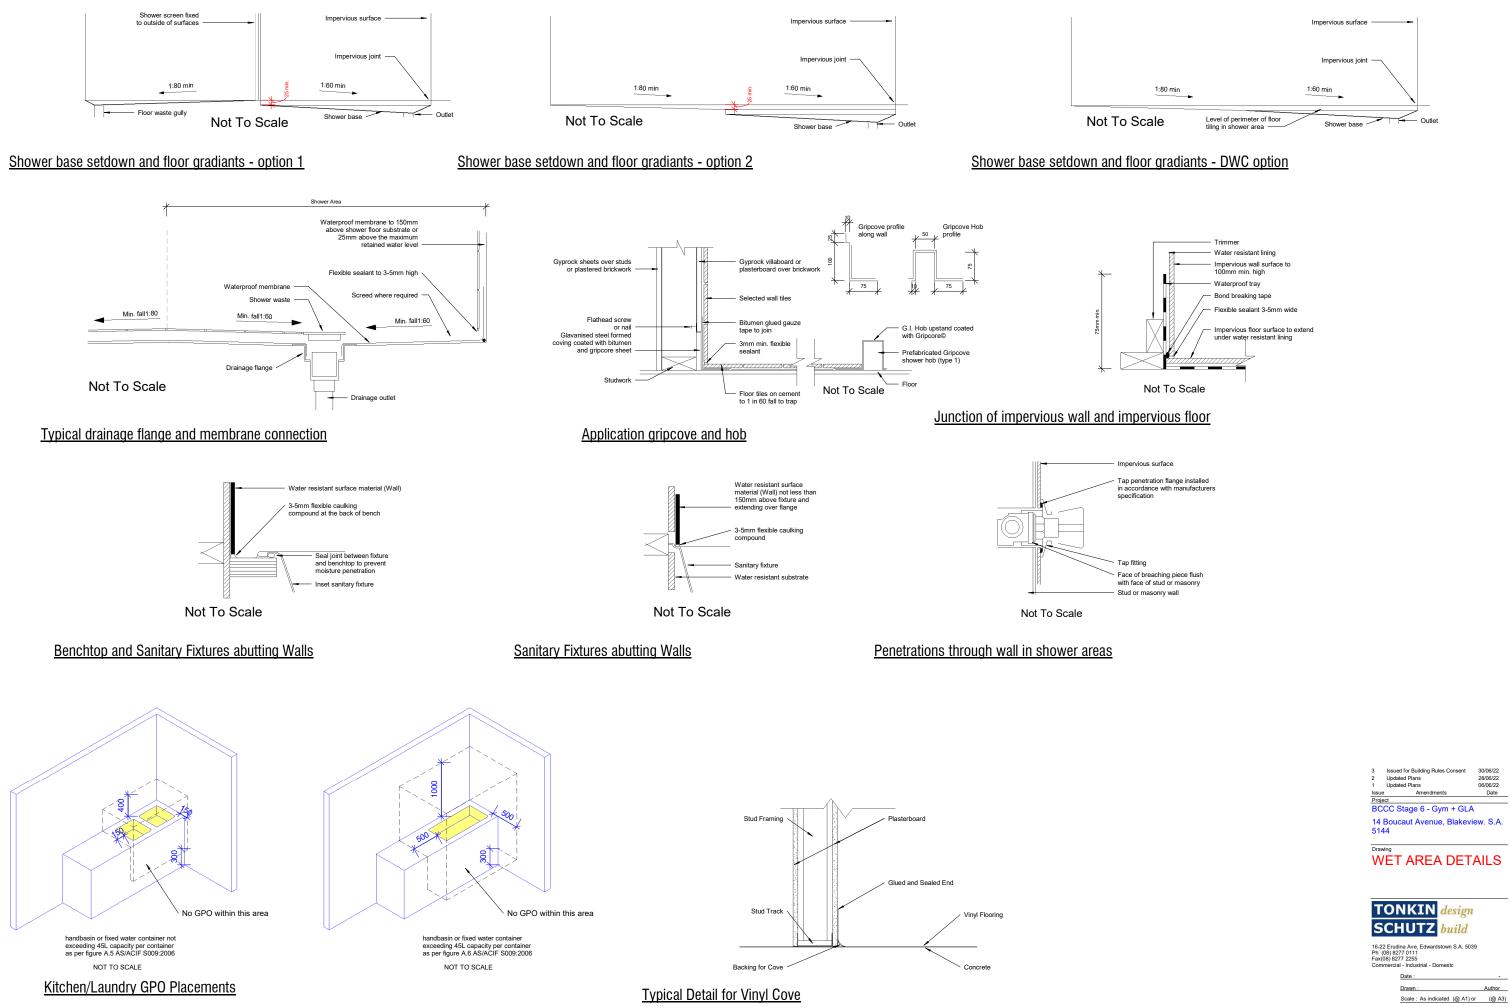
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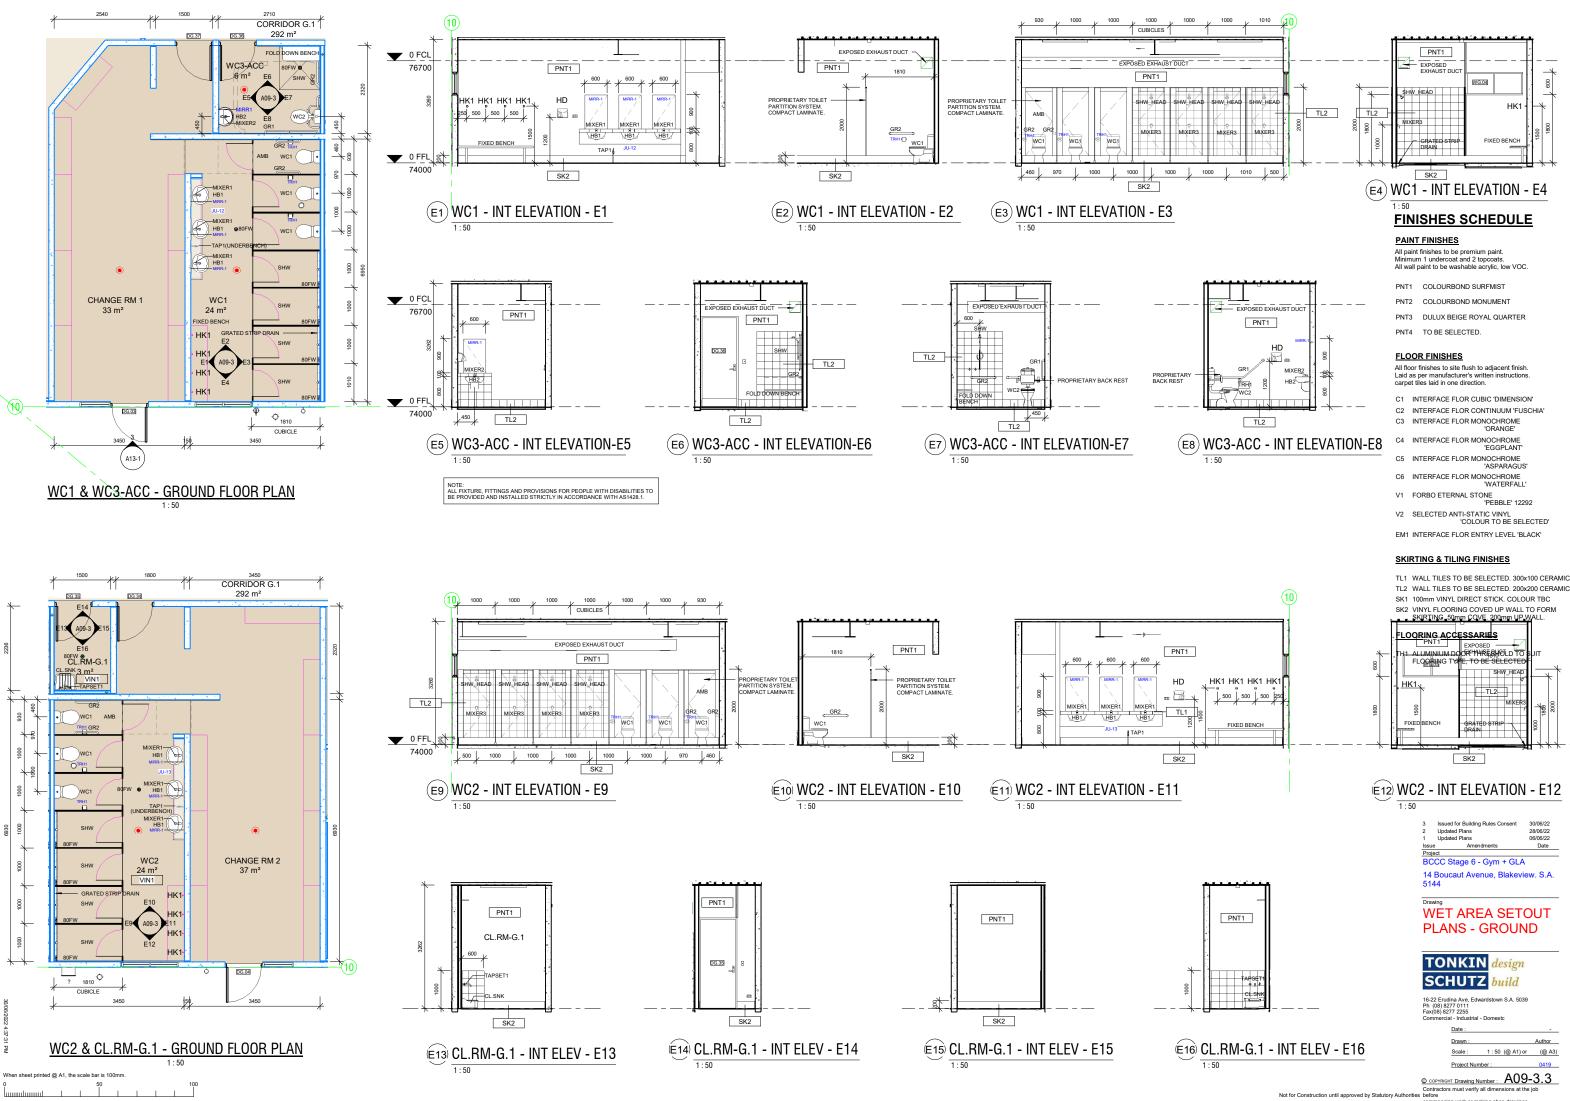
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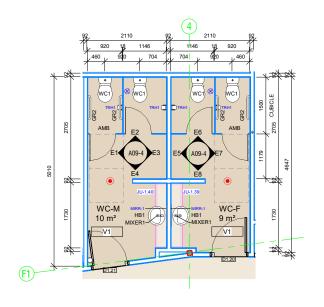
Project Number : 0419

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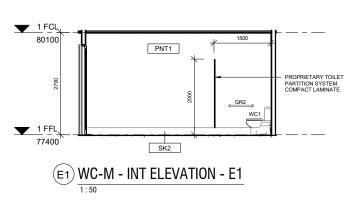
Not for Construction until approved by Statutory Au ncing work or making shop drawings.





ncing work or making shop drawings




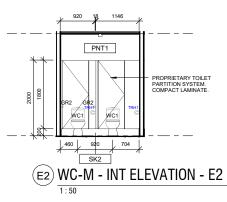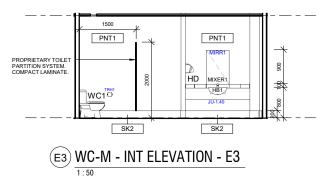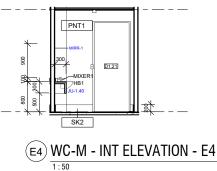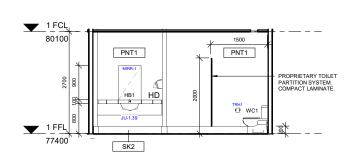
TOILETS - FIRST FLOOR PLAN 1:50














(E5) WC-F - INT ELEVATION - E5 1:50

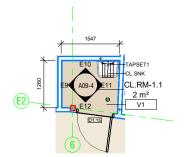


CL.RM-1.1 - FIRST FLOOR PLAN 1:50

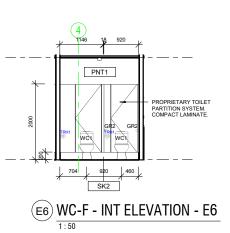


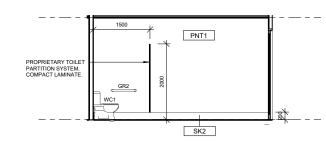


(E7) WC-F - INT ELEVATION - E7 1:50

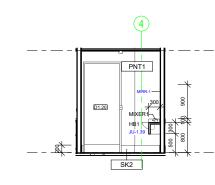


(E8) WC-F - INT ELEVATION - E8 1:50

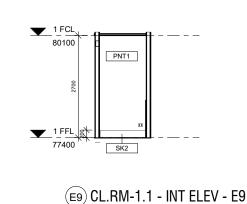


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1:50

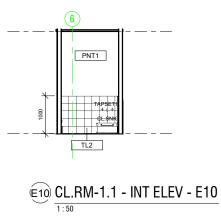(E11) CL.RM-1.1 - INT ELEV - E11 1:50

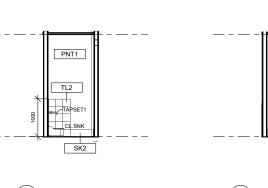

FINISHES SCHEDULE

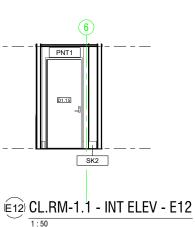PAINT FINISHES

All paint finishes to be premium paint. Minimum 1 undercoat and 2 topcoats. All wall paint to be washable acrylic, low VOC.

PNT1	COLOURBOND SURFMIST

- PNT2 COLOURBOND MONUMENT
- PNT3 DULUX BEIGE ROYAL QUARTER
- PNT4 TO BE SELECTED.

FLOOR FINISHES

All floor finishes to site flush to adjacent finish. Laid as per manufacturer's written instructions carpet tiles laid in one direction.

- C1 INTERFACE FLOR CUBIC 'DIMENSION'
- C2 INTERFACE FLOR CONTINUUM 'FUSCHIA' C3 INTERFACE FLOR MONOCHROME 'ORANGE'
- C4 INTERFACE FLOR MONOCHROME 'EGGPLANT'
- C5 INTERFACE FLOR MONOCHROME 'ASPARAGUS'
- C6 INTERFACE FLOR MONOCHROME 'WATERFALL
- V1 FORBO ETERNAL STONE 'PEBBLE' 12292
- V2 SELECTED ANTI-STATIC VINYL 'COLOUR TO BE SELECTED'
- EM1 INTERFACE FLOR ENTRY LEVEL 'BLACK'

SKIRTING & TILING FINISHES

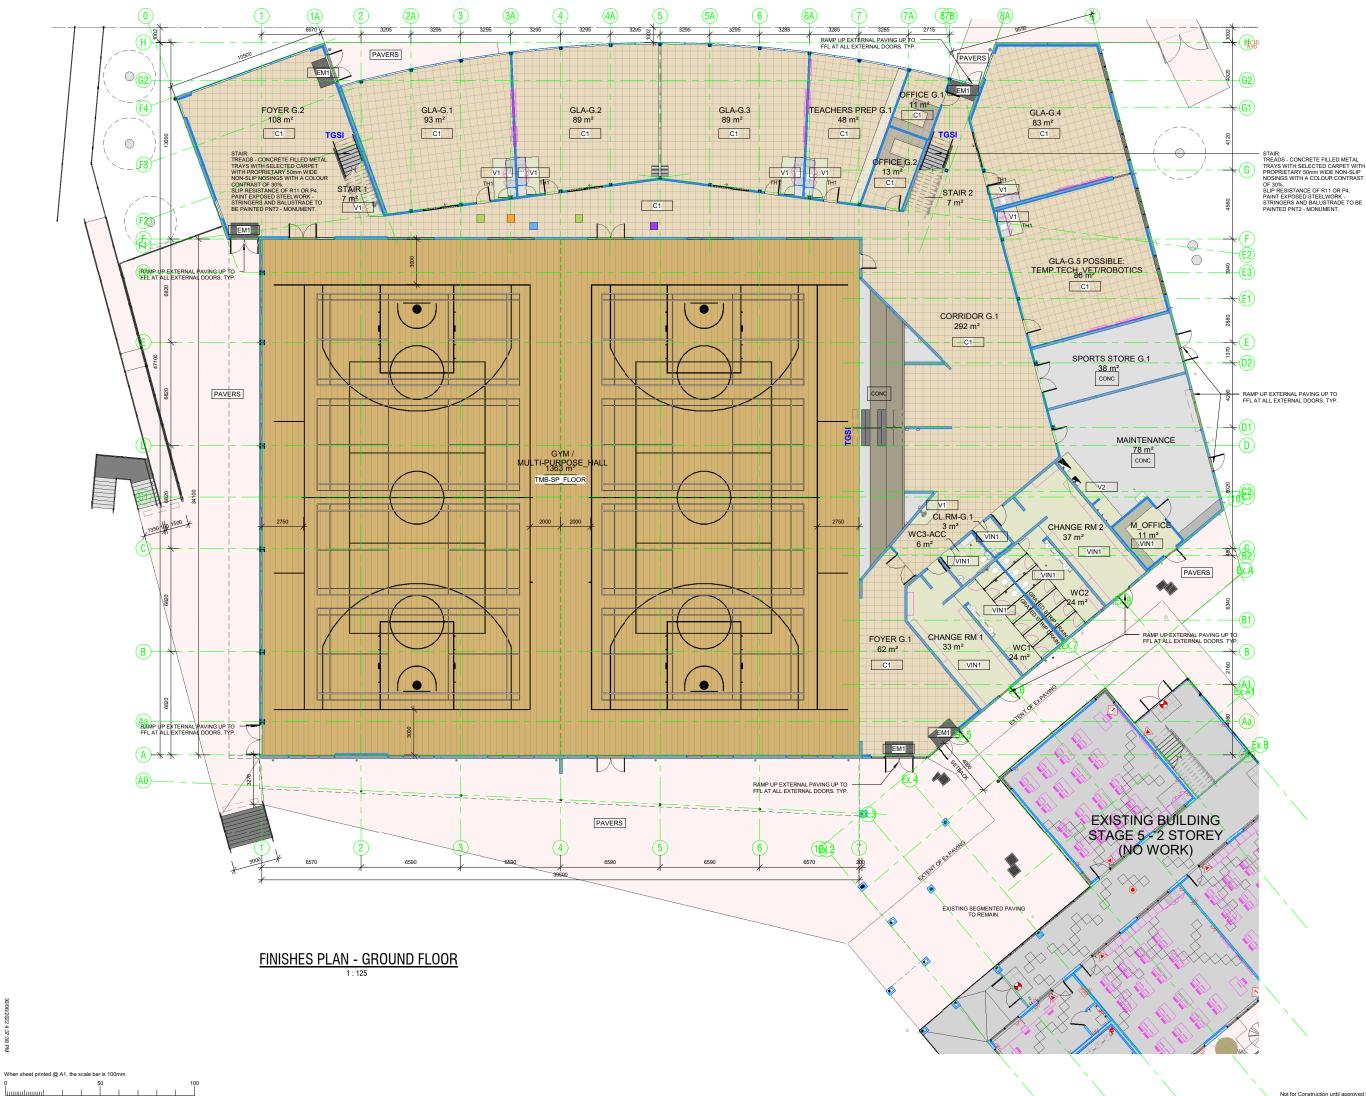
- TL1 WALL TILES TO BE SELECTED. 300x100 CERAMIC.
- TL2 WALL TILES TO BE SELECTED. 200x200 CERAMIC.
- SK1 100mm VINYL DIRECT STICK. COLOUR TBC
- SK2 VINYL FLOORING COVED UP WALL TO FORM SKIRTING. 50mm COVE. 200mm UP WALL.

FLOORING ACCESSARIES

TH1 ALUMINIUM DOOR THRESHOLD TO SUIT FLOORING TYPE, TO BE SELECTED



ncing work or making shop drawings



FINISHES SCHEDULE

PAINT FINISHES

All paint finishes to be premium paint. Minimum 1 undercoat and 2 topcoats. All wall paint to be washable acrylic, low VOC.

- PNT1 COLOURBOND SURFMIST
- PNT2 COLOURBOND MONUMENT
- PNT3 DULUX BEIGE ROYAL QUARTER
- PNT4 TO BE SELECTED.

FLOOR FINISHES

All floor finishes to site flush to adjacent finish. Laid as per manufacturer's written instructions carpet tiles laid in one direction.

- C1 INTERFACE FLOR CUBIC 'DIMENSION'
- C2 INTERFACE FLOR CONTINUUM 'FUSCHIA'
- C3 INTERFACE FLOR MONOCHROME 'ORANGE'
- C4 INTERFACE FLOR MONOCHROME 'EGGPLANT
- C5 INTERFACE FLOR MONOCHROME 'ASPARAGUS'
- C6 INTERFACE FLOR MONOCHROME 'WATERFALL'
- V1 FORBO ETERNAL STONE 'PEBBLE' 12292
- V2 SELECTED ANTI-STATIC VINYL 'COLOUR TO BE SELECTED'
- EM1 INTERFACE FLOR ENTRY LEVEL 'BLACK'

SKIRTING & TILING FINISHES

- TL1 WALL TILES TO BE SELECTED. 300x100 CERAMIC.
- TL2 WALL TILES TO BE SELECTED, 200x200 CERAMIC,
- SK1_100mm VINYL DIRECT STICK, COLOUR TBC
- SK2 VINYL FLOORING COVED UP WALL TO FORM SKIRTING. 50mm COVE. 200mm UP WALL.

FLOORING ACCESSARIES

TH1 ALUMINIUM DOOR THRESHOLD TO SUIT FLOORING TYPE, TO BE SELECTED




FINISHES PLAN -**GROUND FLOOR**



16-22 Erudina Ave, Edwardstown S.A. 5039 Ph (08) 8277 0111 Fax(08) 8277 2255 Commercial - Industrial - Domestc Date : 10/06/22 Drawn :



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FINISHES SCHEDULE

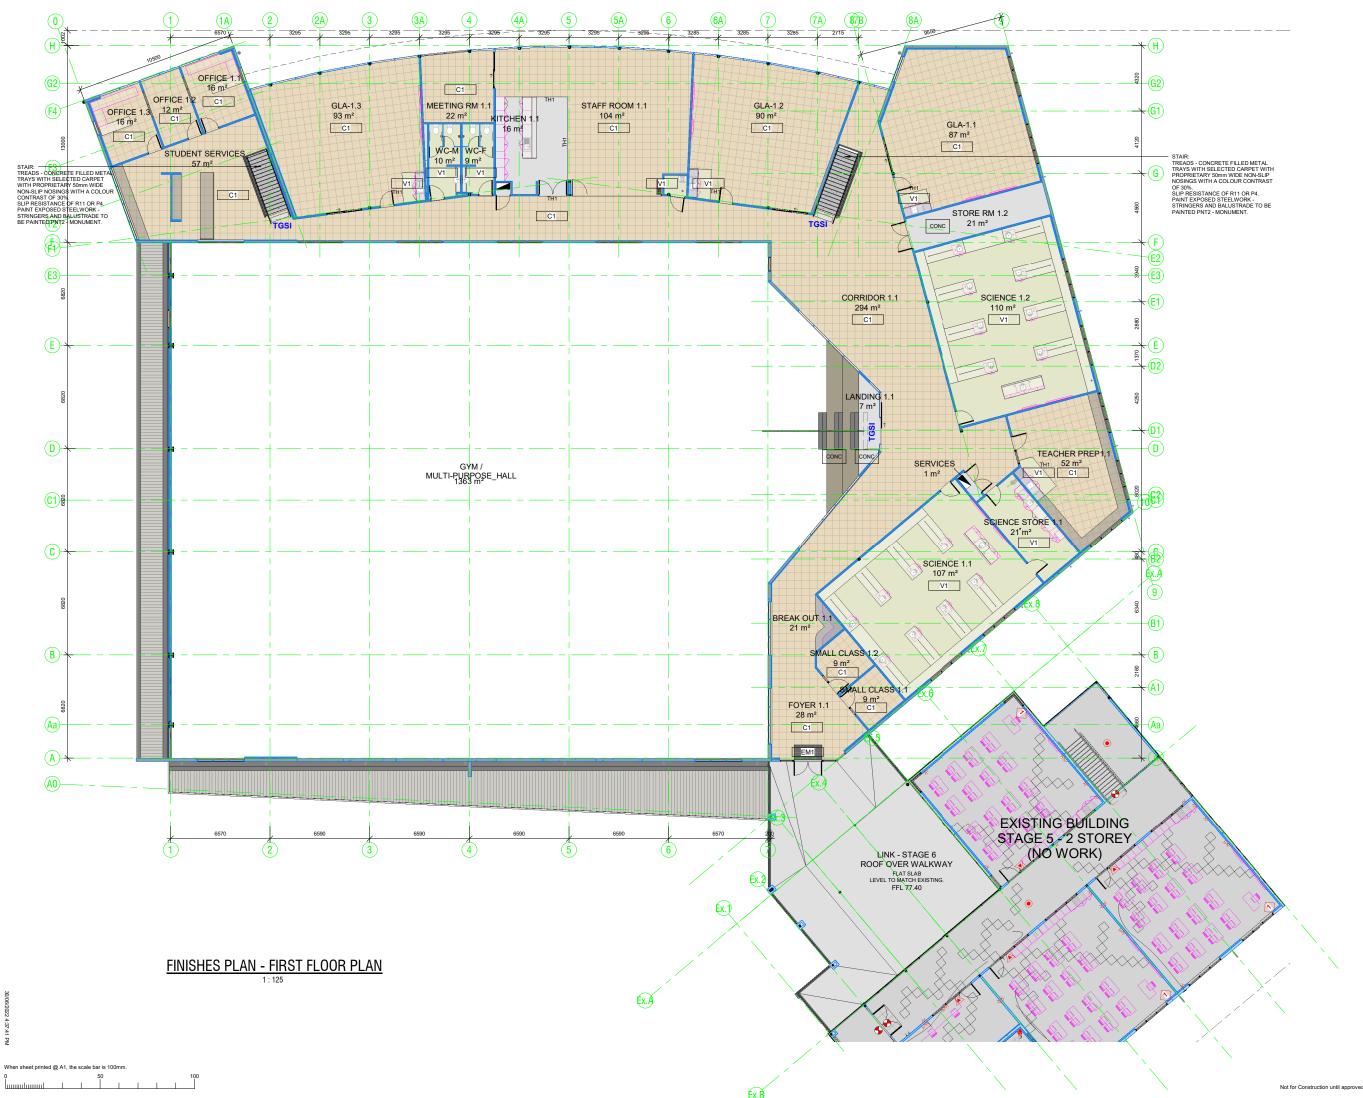PAINT FINISHES

All paint finishes to be premium paint. Minimum 1 undercoat and 2 topcoats. All wall paint to be washable acrylic, low VOC.

- PNT1 COLOURBOND SURFMIST
- PNT2 COLOURBOND MONUMENT
- PNT3 DULUX BEIGE ROYAL QUARTER
- PNT4 TO BE SELECTED.

FLOOR FINISHES

All floor finishes to site flush to adjacent finish. Laid as per manufacturer's written instructions. carpet tiles laid in one direction.

- C1 INTERFACE FLOR CUBIC 'DIMENSION'
- C2 INTERFACE FLOR CONTINUUM 'FUSCHIA' C3 INTERFACE FLOR MONOCHROME
- 'ORANGE
- C4 INTERFACE FLOR MONOCHROME 'EGGPLANT
- C5 INTERFACE FLOR MONOCHROME 'ASPARAGUS'
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- V1 FORBO ETERNAL STONE 'PEBBLE' 12292
- V2 SELECTED ANTI-STATIC VINYL 'COLOUR TO BE SELECTED'
- EM1 INTERFACE FLOR ENTRY LEVEL 'BLACK'

SKIRTING & TILING FINISHES

- TL1 WALL TILES TO BE SELECTED. 300x100 CERAMIC.
- TL2 WALL TILES TO BE SELECTED. 200x200 CERAMIC.
- SK1 100mm VINYL DIRECT STICK. COLOUR TBC
- SK2 VINYL FLOORING COVED UP WALL TO FORM SKIRTING. 50mm COVE. 200mm UP WALL.

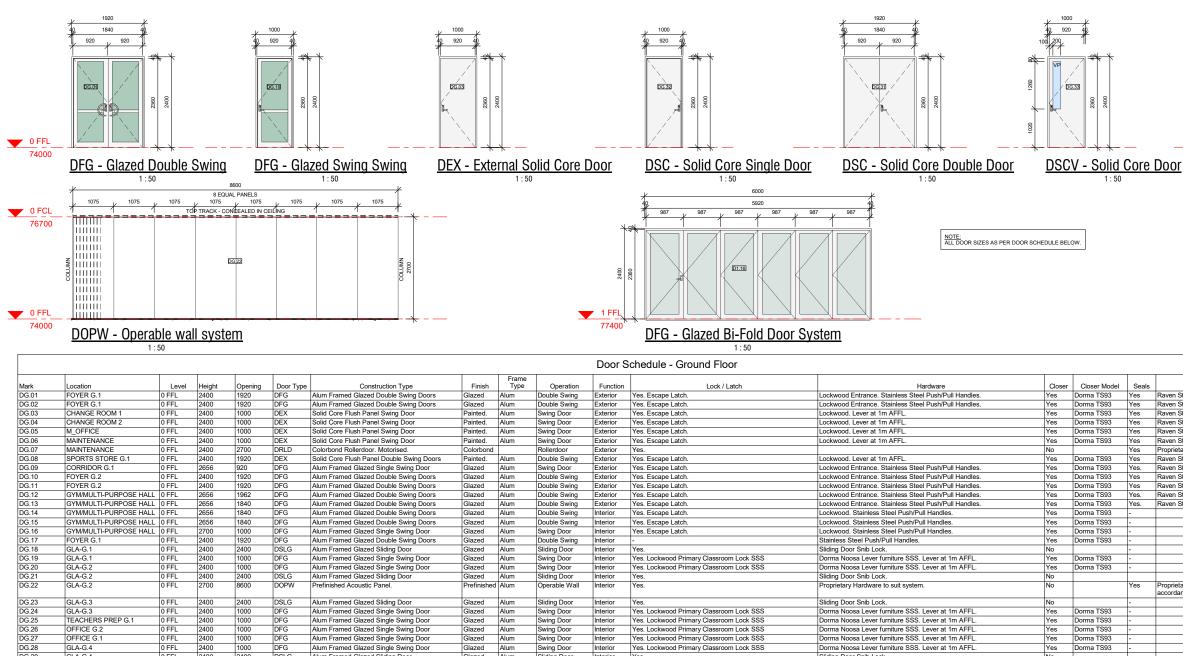
FLOORING ACCESSARIES

TH1 ALUMINIUM DOOR THRESHOLD TO SUIT FLOORING TYPE, TO BE SELECTED



Project Number : 0419 © COPYRIGHT Drawing Number : A10-2.2

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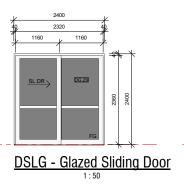
DG.27	OFFICE G.1	0 FFL	2400	1000	DFG	Alum Framed Glazed Single Swing Door	Glazed	Alum	Swing Door	Interior	Yes. Lockwood Primary Classroom Lock SSS	Dorma Noosa Lever furniture SSS. Lever at 1m AFFL.	Yes	Dorma TS93	-	
DG.28	GLA-G.4	0 FFL	2400	1000	DFG	Alum Framed Glazed Single Swing Door	Glazed	Alum	Swing Door	Interior	Yes. Lockwood Primary Classroom Lock SSS	Dorma Noosa Lever furniture SSS. Lever at 1m AFFL.	Yes	Dorma TS93	-	
DG.29	GLA-G.4	0 FFL	2400	2400	DSLG	Alum Framed Glazed Sliding Door	Glazed	Alum	Sliding Door	Interior	Yes.	Sliding Door Snib Lock.	No		-	
DG.30	GLA-G.5	0 FFL	2400	1000	DFG	Alum Framed Glazed Single Swing Door	Glazed	Alum	Swing Door	Interior	Lockwood Primary Classroom Lock SSS	Dorma Noosa Lever furniture SSS. Lever at 1m AFFL.	Yes		-	
DG.31	SPORTS STORE G.1	0 FFL	2400	1920	DSC	Solid Core Flush Panel Double Swing Doors	Painted.	Alum	Double Swing	Interior	Yes.	Lockwood. Lever at 1m AFFL.	Yes	Dorma TS93	-	
DG.32	MAINTENANCE	0 FFL	2400	1000	DSC	Solid Core Flush Panel Swing Door	Painted.	Alum	Swing Door	Interior	Yes.	Lockwood. Lever at 1m AFFL.	Yes	Dorma TS93	Yes	
DG.33	M_OFFICE	0 FFL	2400	1000	DSCV	Solid Core Flush Panel Swing Door with Viewing Panel	Painted.	Alum	Swing Door	Interior	Yes.	Lockwood. Lever at 1m AFFL.	Yes	Dorma TS93	Yes	Viewing Pa
DG.34	CHANGE ROOM 2	0 FFL	2400	1000	DSC	Solid Core Flush Panel Swing Door	Painted.	Alum	Swing Door	Interior	Yes.	Lockwood. Push/Pull Handles. SS Kick Plates.	Yes	Dorma TS93	No	Braille Sigr
DG.35	CL.RM-G.1	0 FFL	2400	1000	DSC	Solid Core Flush Panel Swing Door	Painted.	Alum	Swing Door	Interior	Yes.	Lockwood. Lever at 1m AFFL.	Yes	Dorma TS93	No	Signage wi
DG.36	WC3-ACC	0 FFL	2400	1000	DSC	Solid Core Flush Panel Swing Door	Painted.	Alum	Swing Door	Interior	Yes.	Privacy Set. SS Kick Plates.	Yes	Dorma TS93	No	Braille Sigr Hinges.
DG.37	CHANGE ROOM 1	0 FFL	2400	1000	DSC	Solid Core Flush Panel Swing Door	Painted.	Alum	Swing Door	Interior	Yes.	Lockwood. Push/Pull Handles. SS Kick Plates.	Yes	Dorma TS93	No	Braille Sigr

										Door	Schedule - First Floor					
Mark	Location	Level	Height	Opening	Door Type	Construction Type	Finish	Frame Type	Operation	Function	Lock / Latch	Hardware	Closer	Closer Model	Seals	
D1.01	FOYER 1.1	1 FFL	2400	1920	DFG	Alum Framed Glazed Double Swing Doors	Glazed	Alum	Double Swing	Exterior	Yes. Escape Latch.	Lockwood Entrance. Stainless Steel Push/Pull Handles.	Yes	Dorma TS93	Yes	Raven Storr
D1.02	SMALL CLASS 1.1	1 FFL	2400	1000	DFG	Alum Framed Glazed Single Swing Door	Glazed	Alum	Swing Door	Interior	Yes. Lockwood Primary Classroom Lock SSS	Dorma Noosa Lever furniture SSS. Lever at 1m AFFL.	Yes	Dorma TS93		
D1.03	SMALL CLASS 1.2	1 FFL	2400	1000	DFG	Alum Framed Glazed Single Swing Door	Glazed	Alum	Swing Door	Interior	Yes. Lockwood Primary Classroom Lock SSS	Dorma Noosa Lever furniture SSS. Lever at 1m AFFL.	Yes	Dorma TS93		
D1.04	SCIENCE 1.1	1 FFL	2400	1000	DFG	Alum Framed Glazed Single Swing Door	Glazed	Alum	Swing Door	Interior	Yes. Lockwood Primary Classroom Lock SSS	Dorma Noosa Lever furniture SSS. Lever at 1m AFFL.	Yes	Dorma TS93		
D1.05	SERVICES 1.1	1 FFL	2100	1800	DFC	Solid Core Flush Panel Double Swing Doors	Painted.	Alum	Double Swing	Interior	Yes.	Lockwood. Lever at 1m AFFL.	Yes	Dorma TS93		
D1.06	SCIENCE STORE 1.1	1 FFL	2400	1000	DFG	Alum Framed Glazed Single Swing Door	Glazed	Alum	Swing Door	Interior	Yes. Lockwood Primary Classroom Lock SSS	Dorma Noosa Lever furniture SSS. Lever at 1m AFFL.	Yes	Dorma TS93		
D1.07	SCIENCE STORE 1.1	1 FFL	2400	1000	DFG	Alum Framed Glazed Single Swing Door	Glazed	Alum	Swing Door	Interior	Yes.	Dorma Noosa Lever furniture SSS. Lever at 1m AFFL.	Yes	Dorma TS93		
D1.08	TEACHERS PREP 1.1	1 FFL	2400	1000	DFG	Alum Framed Glazed Single Swing Door	Glazed	Alum	Swing Door	Interior	Yes. Lockwood Primary Classroom Lock SSS	Dorma Noosa Lever furniture SSS. Lever at 1m AFFL.	Yes	Dorma TS93		
D1.09	SCIENCE 1.2	1 FFL	2400	1000	DFG	Alum Framed Glazed Single Swing Door	Glazed	Alum	Swing Door	Interior	Yes. Lockwood Primary Classroom Lock SSS	Dorma Noosa Lever furniture SSS. Lever at 1m AFFL.	Yes	Dorma TS93		
D1.10	STORE RM 1.2	1 FFL	2400	1920	DSC	Solid Core Flush Panel Double Swing Doors	Painted.	Alum	Double Swing	Interior	Yes.	Lockwood. Lever at 1m AFFL.	Yes	Dorma TS93		
D1.11	GLA-1.1	1 FFL	2400	1000	DFG	Alum Framed Glazed Single Swing Door	Glazed	Alum	Swing Door	Interior	Yes. Lockwood Primary Classroom Lock SSS	Dorma Noosa Lever furniture SSS. Lever at 1m AFFL.	Yes	Dorma TS93		
D1.12	GLA-1.1	1 FFL	2400	2400	DSLG	Alum Framed Glazed Sliding Door	Glazed	Alum	Sliding Door	Interior	Yes.	Sliding Door Snib Lock.	No			
D1.13	GLA-1.2	1 FFL	2400	2400	DSLG	Alum Framed Glazed Sliding Door	Glazed	Alum	Sliding Door	Interior	Yes.	Sliding Door Snib Lock.	No			
D1.14	GLA-1.2	1 FFL	2400	1000	DFG	Alum Framed Glazed Single Swing Door	Glazed	Alum	Swing Door	Interior	Yes. Lockwood Primary Classroom Lock SSS	Dorma Noosa Lever furniture SSS. Lever at 1m AFFL.	Yes	Dorma TS93		
D1.15	CL.RM-1.1	1 FFL	2400	1000	DSC	Solid Core Flush Panel Swing Door	Painted.	Alum	Swing Door	Interior	Yes.	Lockwood. Lever at 1m AFFL.	Yes	Dorma TS93		Signage with
D1.16	STAFF ROOM 1.1	1 FFL	2400	6000	DFG	Alum Framed Glazed Bi-Fold Doors	Glazed	Alum	Bi-Fold with swing door	Interior	Yes.	Proprietary Hardware to suit system.	No			
D1.17	STAFF ROOM 1.1	1 FFL	2400	1920	DFG	Alum Framed Glazed Double Swing Doors	Glazed	Alum	Double Swing	Interior	Yes. Escape Latch.	Lockwood Entrance. Stainless Steel Push/Pull Handles.	Yes	Dorma TS93		
D1.18	MEETING RM 1.1	1 FFL	2400	2400	DSLG	Alum Framed Glazed Sliding Door	Glazed	Alum	Sliding Door	Interior	Yes.	Sliding Door Snib Lock.	No			
D1.19	DB	1 FFL	2400	1000	DSC	Solid Core Flush Panel Swing Door	Painted.	Alum	Swing Door	Interior	Yes.	Lockwood. Lever at 1m AFFL.	Yes	Dorma TS93		
D1.20	WC-F	1 FFL	2400	1000	DSC	Solid Core Flush Panel Swing Door	Painted.	Alum	Swing Door	Interior	No.	Push/Pull Handles. SS Kick Plates.	Yes	Dorma TS93		Braille Signa
D1.21	WC-M	1 FFL	2400	1000	DSC	Solid Core Flush Panel Swing Door	Painted.	Alum	Swing Door	Interior	No.	Push/Pull Handles. SS Kick Plates.	Yes	Dorma TS93		Braille Signa
D1.22	GLA-1.3	1 FFL	2400	1000	DFG	Alum Framed Glazed Single Swing Door	Glazed	Alum	Swing Door	Interior	Yes. Lockwood Primary Classroom Lock SSS	Dorma Noosa Lever furniture SSS. Lever at 1m AFFL.	Yes	Dorma TS93		
D1.23	GLA-1.3	1 FFL	2400	2400	DSLG	Alum Framed Glazed Sliding Door	Glazed	Alum	Sliding Door	Interior	Yes.	Sliding Door Snib Lock.	No			
D1.24	OFFICE 1.1	1 FFL	2400	1000	DFG	Alum Framed Glazed Single Swing Door	Glazed	Alum	Swing Door	Interior	Yes.	Lockwood. Lever at 1m AFFL.	Yes	Dorma TS93		
D1.25	OFFICE 1.2	1 FFL	2400	1000	DFG	Alum Framed Glazed Single Swing Door	Glazed	Alum	Swing Door	Interior	Yes.	Lockwood. Lever at 1m AFFL.	Yes	Dorma TS93		
D1.26	OFFICE 1.3	1 FFL	2400	1000	DFG	Alum Framed Glazed Single Swing Door	Glazed	Alum	Swing Door	Interior	Yes.	Lockwood. Lever at 1m AFFL.	Yes	Dorma TS93		
D1.27	LANDING 1.1	1 FFL	2656	1700	DEG	Alum Framed Glazed Sliding Door	Glazed	Alum	Sliding Door	Interior	No.	Pull/Pull Handle.	No			

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LEG	END
DEX	External Solid Core Door
DFG	External / Internal Glazed Swing Door
DSC	Internal Solid Core Door
DSCV	Internal Solid Core Door with viewing pane
DSLG	Internal Glazed Sliding Door
DRLD	Colorbond Rollerdoor - Motorised.
DOPW	Internal Operable Wall
FG	Fixed Glass
FC	Insulated Panels. Insert FC Sheet into glazing framing, instead of glass. Painted. Fix second sheet of FC, to inside of glazing frame. Pack / fill void between sheets with R2.5 Insulation Batts.
AW	Openable - Top hung awning. Lockable.
SJ	Silicon Joint
FC	9mm FC Sheet. Painted both sides.
MTF	Motif or decal of not less than 75mm wide and at 900mm to 1000mm above FGL to glazing capable of being mistaken for a doorway or opening on an acessway where not provided with chair rail, transom or handrail.
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	nechanical documentation for location undercut requirements
and / o	ing to be in accordance with AS1288 r AS2047 as appropriate.
to be a Externa	specified otherwise glass colouring s follows: al - Supergreen, to match existing(C.O.S.) I - Clear
All exte head s	rnal windows to have sub-sills and ills
2	Issued for Building Rules Consent 30/06/22 Updated Plans 28/06/22

2	Issued for Building Rules Consent	30/06/22
1	Updated Plans	28/06/22
Issue	Amendments	Date
Proje	ct	
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14	Reveaut Avenue, Plakey	

14 Boucaut Avenue, Blakeview. S.A. 5144

Drawing DOOR SCHEDULE

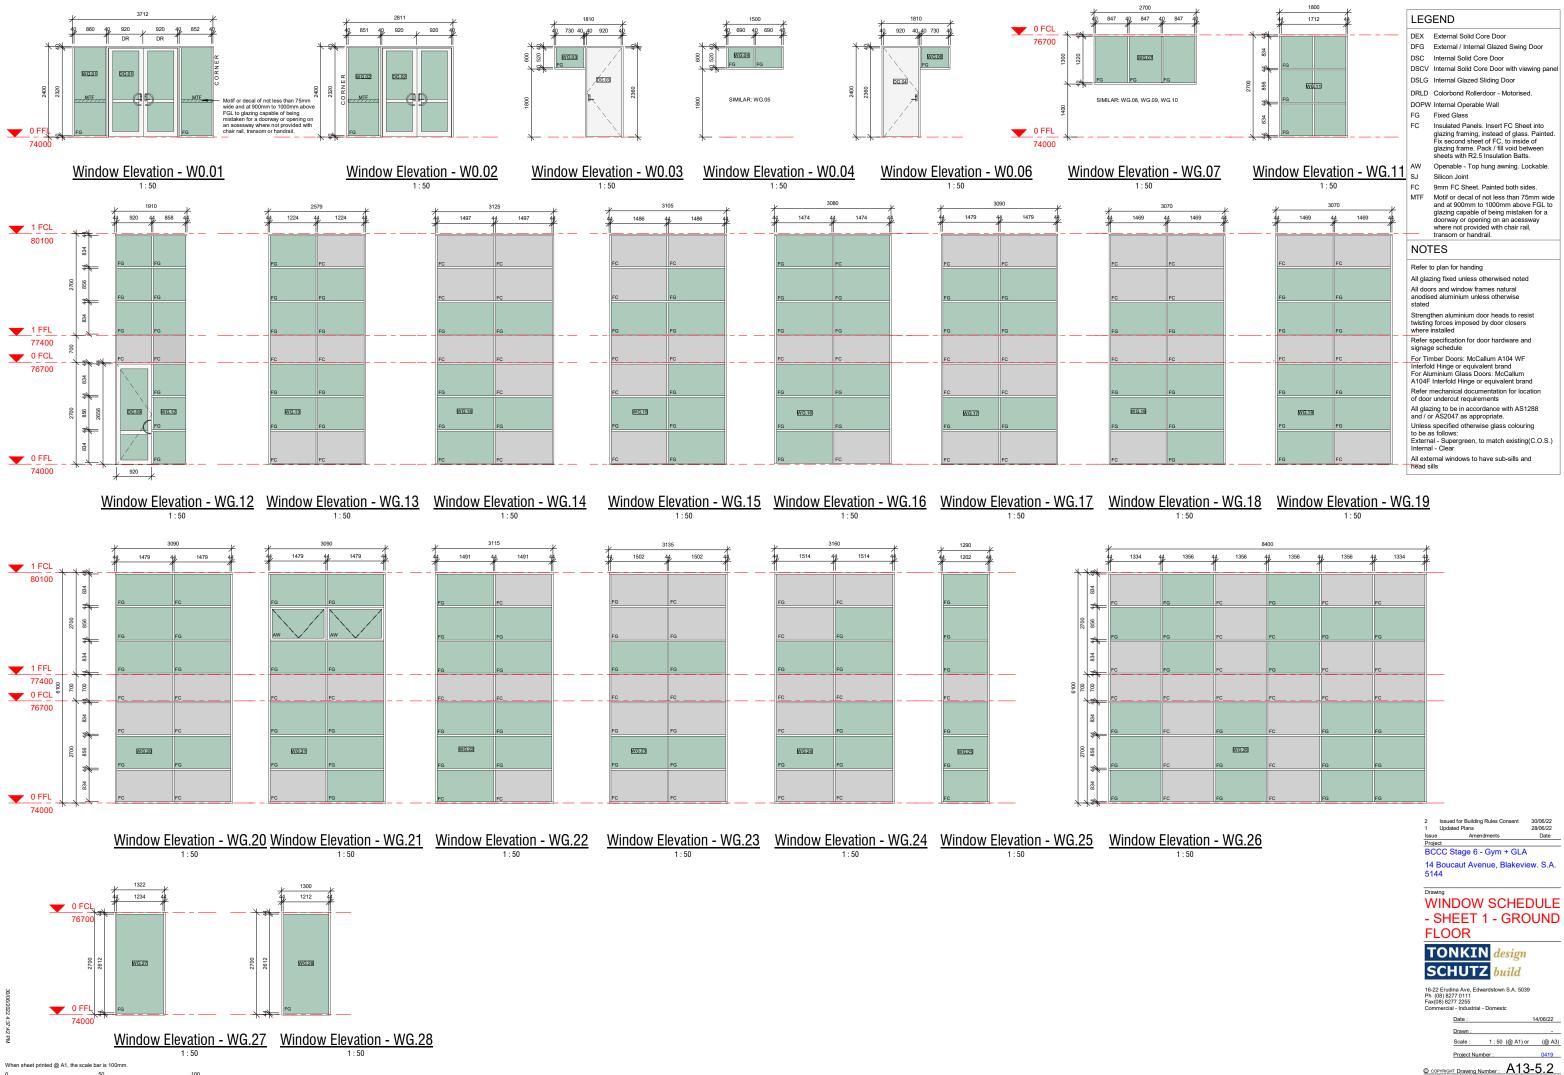


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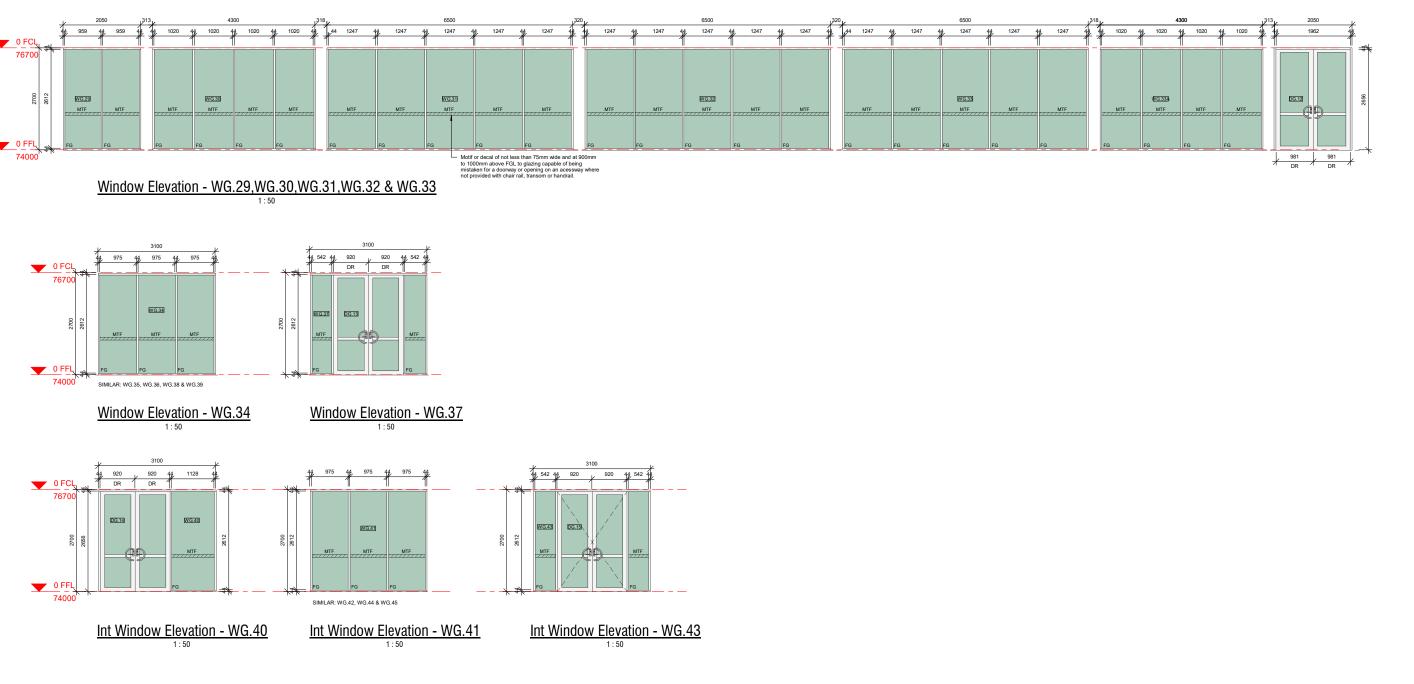
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LEGEND

DEX	External Solid Core Door
DFG	External / Internal Glazed Swing Door
DSC	Internal Solid Core Door
DSCV	Internal Solid Core Door with viewing panel
DSLG	Internal Glazed Sliding Door
DRLD	Colorbond Rollerdoor - Motorised.
DOPW	Internal Operable Wall
FG	Fixed Glass
FC	Insulated Panels. Insert FC Sheet into glazing framing, instead of glass. Painted. Fix second sheet of FC, to inside of glazing frame. Pack / fill void between sheets with R2.5 Insulation Batts.
AW	Openable - Top hung awning. Lockable.
SJ	Silicon Joint
FC	9mm FC Sheet. Painted both sides.
MTF	Motif or decal of not less than 75mm wide and at 900mm to 1000mm above FGL to glazing capable of being mistaken for a doorway or opening on an acessway where not provided with chair rail, transom or handrail.
NOT	FS

NOTES

Refer to plan for handing All glazing fixed unless otherwised noted All doors and window frames natural anodised aluminium unless otherwise stated Strengthen aluminium door heads to resist twisting forces imposed by door closers where installed Refer specification for door hardware and Refer specification for door hardware and signage schedule For Timber Doors: McCallum A104 WF Interfold Hinge or equivalent brand For Aluminum Glass Doors: McCallum A104F Interfold Hinge or equivalent brand Refer mechanical documentation for location of door undercut requirements All glazing to be in accordance with AS1288 and / or AS2047 as appropriate. Unless specified otherwise glass colouring to be as follows: External - Supergreen, to match existing(C.O.S.) Internal - Clear

All external windows to have sub-sills and head sills

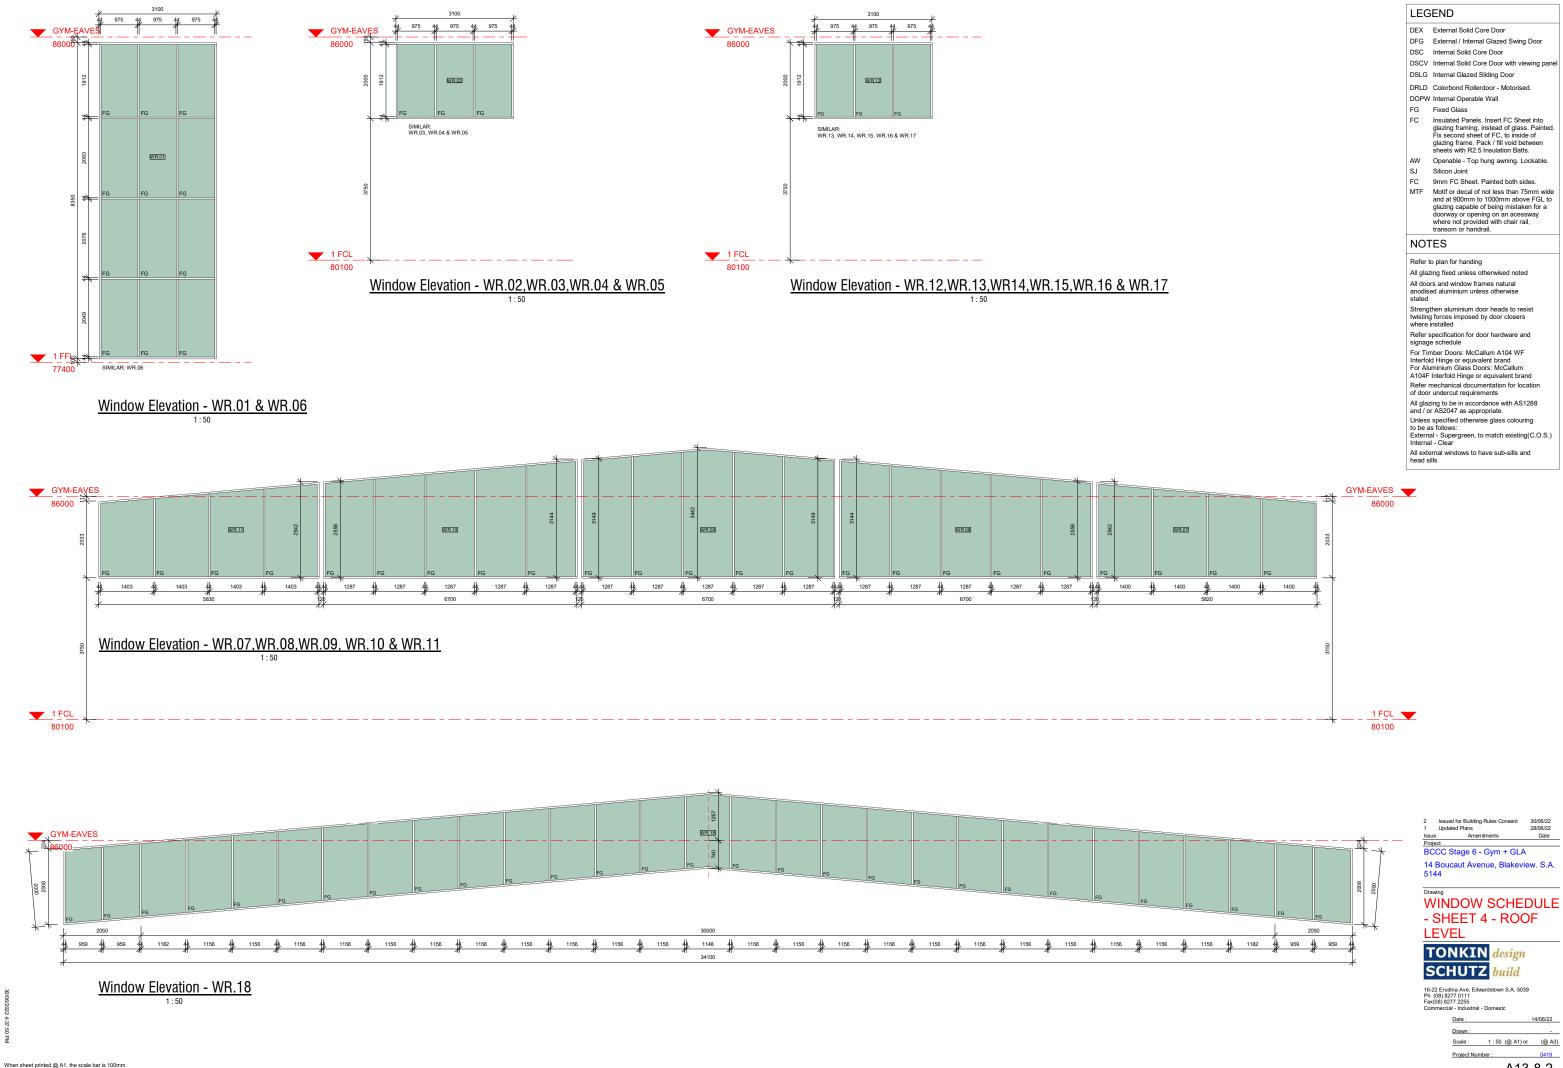


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